City of Worcester Historical Commission



Building Demolition Delay Waiver Application

Planning & Regulatory 455 Main Street - Room 404, Worcester, MA 01608 Phone 508-799-1400, x31440 - Fax 508-799-1406 - E-mail planning@worcesterma.gov

1. Building Address/Location: 55 Salisbury Street Worcester MA 01609

Date: April 11, 2024

2. Year Originally Built: 1898

Source: Massachusetts Cultural Resource Information System (MACRIS)

3. Description of Work: (i.e. Scope of work. List and explain each proposed change separately, Include description of materials and condition of items to be impacted.)

Area of Work

Partial Demolition of Building(s)

Describe "Other" Area of Work

Scope of Work - Describe Work to be Completed

A) Fuller Conservation Lab Roof & Skylight Replacement (1930s Roof Phase 2: Following the completion of the 1930s Roof Replacement (Phase 1) approved in AUG2022, WAM plans to remove and replace the 1983 sloped roof and skylight assembilies over the Fuller Conservation Lab per the SGH drawing set with oversight and coordination by Sam Anderson Architects.

- B) Condenser Line Chase, Masonry Infill: Repurposing an under utilized brick masonry shaft and abondoned hoistway east of the building centerline, WAM seeks to infill two small masonry openings at the rooftop adjacent to the boiler chimney above the 1898 building. The Engineer of Record is Caputo & Wick, Describe the Condition of Existing Materials to be Removed
- A) Fuller Conservation Lab Roof & Skylight Replacement: The existing skylights are failing and require replacement. System details related to the skylights, sloped roof, and adjacent limestone wall require improvement as water infiltration and condensation have been an ongoing problem.
- B) Condenser Line Chase, Masonry Infill: Per the existing conditions image provided, the vent opening currently exists. The scope of work will focus on infilling the existing opening.

Describe Proposed Materials

- A) Fuller Conservation Lab:
- 1) Roof Replacement: Simulated- Metal Standing Seam Roof (SINGLE-PLY ADHERED PVC MEMBRANE) w/ code required insulation. PVC membrane color to match existing roof assembly as best as possible.
- 2) Skylights. Aluminum-framed tripled-paned skylight assembly.
- 3) Limestone Wall: Existing limestone to salvage where possible and replaced to match where necessary.
- B) Condenser Line Chase, Masonry Infill: New brick masonry & detailing to match new, previously approved infills located on other elevations of the 1898 building.
- 4. Reasons for Proposed Work: (e.g. Renovation, maintenance, addition, new use, code violation, etc.)
 - A) Fuller Conservation Lab Roof & Skylights: The existing assemblies are beyond their lifecycle and are failing.
 - B) Condenser Line Chase, Masonry Infill: Infill existing brick masonry open at rooftop chimney.

5. Applicant Name:

Seth Wiseman

6. Owner Information:

DBA Name: (If Provided):

Worcester Art Museum

Owner Name:

Matthias Waschek

Owner Address:

55 Salisbury Street Worcester MA 01609 Worcester MA 01609

Date:

Owner Phone:

(508) 799-4406

Owner Email:

MatthiasWaschek@worcesterart.org

Owner's Signature certifying that the above information is true and accurate to the best of his/her knowledge.
(This because whether the Applicant is not the same as the Owner)

Paul Comerford

4/12/2024

Paul Comerford

Worcester Art Museum

Director of Facilities





1930s BUILDING ROOF & FULLER LAB ENVELOPE IMPROVEMENTS

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PHASE 1 AND 2 - PERMIT SET


		DRAWING LIST
SHEET NUMBER	PHASE	SHEET NAME
G-000		COVER SHEET AND DRAWING INDEX
G-100		SITE PLAN
G-101	- y =	PHASING
G-300		TYPICAL METAL DETAILS
G-301	10 1	TYPICAL METAL DETAILS
G-302	- 5/4	TYPICAL CONCRETE REPAIR DETAILS
R1-100	PHASE 1	ROOF REMOVAL PLAN
R1-200	PHASE 1	MECHANICAL ROOM REMOVAL ELEVATIONS
R1-201	PHASE 1	COVERED SKYLIGHT REMOVAL ELEVATION
R1-202	PHASE 1	PARAPET REMOVAL ELEVATIONS
R1-203	PHASE 1	FULLER LAB REMOVAL ELEVATIONS
R1-300	PHASE 1	REMOVAL DETAILS
BT1-100	PHASE 1	1930s ROOF PLAN
BT1-101	PHASE 1	FULLER ROOF AND MECHANICAL ROOM ROOFS
BT1-200	PHASE 1	MECHANICAL ROOM ELEVATIONS
BT1-201	PHASE 1	PARTIAL ELEVATIONS
BT1-202	PHASE 1	PARAPET ELEVATIONS
BT1-203	PHASE 1	FULLER LAB PARTIAL ELEVATIONS
BT1-300	PHASE 1	MODIFIED BITUMEN ROOF DETAILS
BT1-310	PHASE 1	EPDM ROOF DETAILS
BT1-320	PHASE 1	BUILT-IN GUTTER AND FLASHING DETAILS
BT1-321	PHASE 1	BUILT-IN GUTTER AND FLASHING DETAILS
BT1-330	PHASE 1	METAL PANEL INFILL DETAILS
BT1-340	PHASE 1	PENTHOUSE CLADDING DETAILS
R2-100	PHASE 2	FULLER ROOF REMOVAL PLAN
R2-200	PHASE 2	FULLER LAB REMOVAL ELEVATIONS
R2-201	PHASE 2	FULLER LAB WALL PART PLAN AND INTERIOR REMOVAL ELEVATION
BT2-100	PHASE 2	FULLER ROOF PLAN
BT2-200	PHASE 2	FULLER LAB PARTIAL ELEVATIONS
BT2-201	PHASE 2	FULLER LAB WALL PART PLAN AND INTERIOR ELEVATION
BT2-300	PHASE 2	PVC ROOF DETAILS
BT2-301	PHASE 2	PVC ROOF DETAILS
BT2-310	PHASE 2	WINDOW DETAILS
BT2-320	PHASE 2	UHPC CLADDING DETAILS

	1	STRUCTURAL DRAWINGS
Sheet Number	PHASE	Sheet Name
S0-001		SPECIAL TESTING & INSPECTION PROCEDURES
S0-003		SPECIAL TESTING & INSPECTION PROCEDURES
S0-010		TYPICAL DETAILS
S0-011		TYPICAL DETAILS
S0-300	PHASE 1, 2 & 3	SECTIONS AND DETAILS
S1-000		GENERAL NOTES
S1-002		SPECIAL TESTING & INSPECTION PROCEDURES
S1-100	PHASE 1	STRUCTURAL 1931 ROOF PLAN
S1-101	PHASE 1	STRUCTURAL HIGH ROOF PLAN
S1-301	PHASE 1	SECTIONS AND DETAILS
S1-302	PHASE 1	SECTIONS AND DETAILS
S1-303	PHASE 1	SECTIONS AND DETAILS
S2-102	PHASE 2	FULLER PART PLANS
S2-302	PHASE 2	SECTIONS AND DETAILS



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KEY PLA

5	7/22/22	PHASE 1 AND 2 - PERMIT SET	
4	03/31/22	PHASE 3 - 90% CDs	
3	02/11/22	PHASE 1 AND 2 BID SET	
2	12/16/21	50% CONSTRUCTION DOCUMENTS	
1	10/28/21	100% DESIGN DEVELOPMENT	
No.	Date	Description	Ву

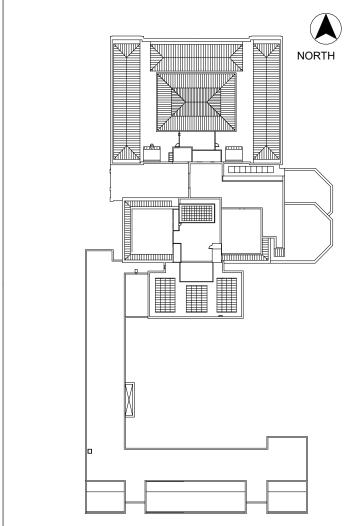1930s Building Roof & Fuller Lab Envelope Improvements

WORCESTER ART MUSEUM WORCESTER, MA

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COVER SHEET AND DRAWING INDEX

Drawing T


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//Roof & Fuller Lab Envelope Improvements/210608.00_WAM-ROOF_R21_CENTRAL.rvt

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SITE NOTES:

1. SUBMIT SITE PLAN FOR APPROVAL SHOWING LAYDOWN AREAS, FENCING LAYOUT, SCAFFOLDING (IF ANY), HOISTS, SECURITY PROVISIONS, SITE LIGHTING, AND PROTECTION. REFER TO REQUIREMENTS IN THE SPECIFICATIONS.

- 2. PROTECT (E) TREES, LIGHTING, ART INSTALLATIONS, AND OTHER PERMANENT STRUCTURES AND UTILITIES. 3. AFTER CONSTRUCTION, REMOVE FENCE AND POSTS, RESTORE
- LANDSCAPING TO ORIGINAL CONDITION.


 PROVIDE SAFE PUBLIC ACCESS ALONG SIDEWALKS AND TO BUILDING ENTRANCES.
- 5. MAINTAIN EMERGENCY EGRESS PATHS FROM THE BUILDING.6. STORAGE IS NOT ALLOWED ON THE ROOFS.

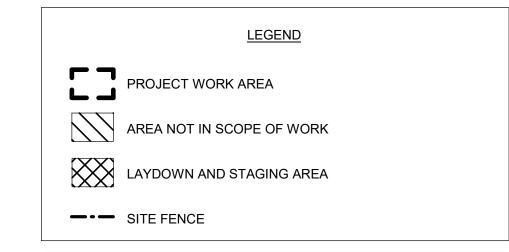WHC, Area of Interest
Phase 2: Fuller Conservation
Lab Roof & Skylight Replacement



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KEY PLAN

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1930s Building Roof & Fuller Lab Envelope **Improvements**

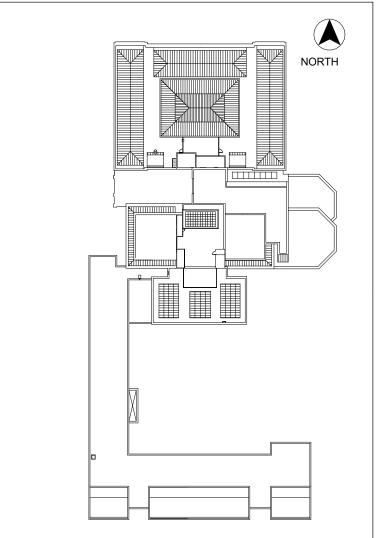
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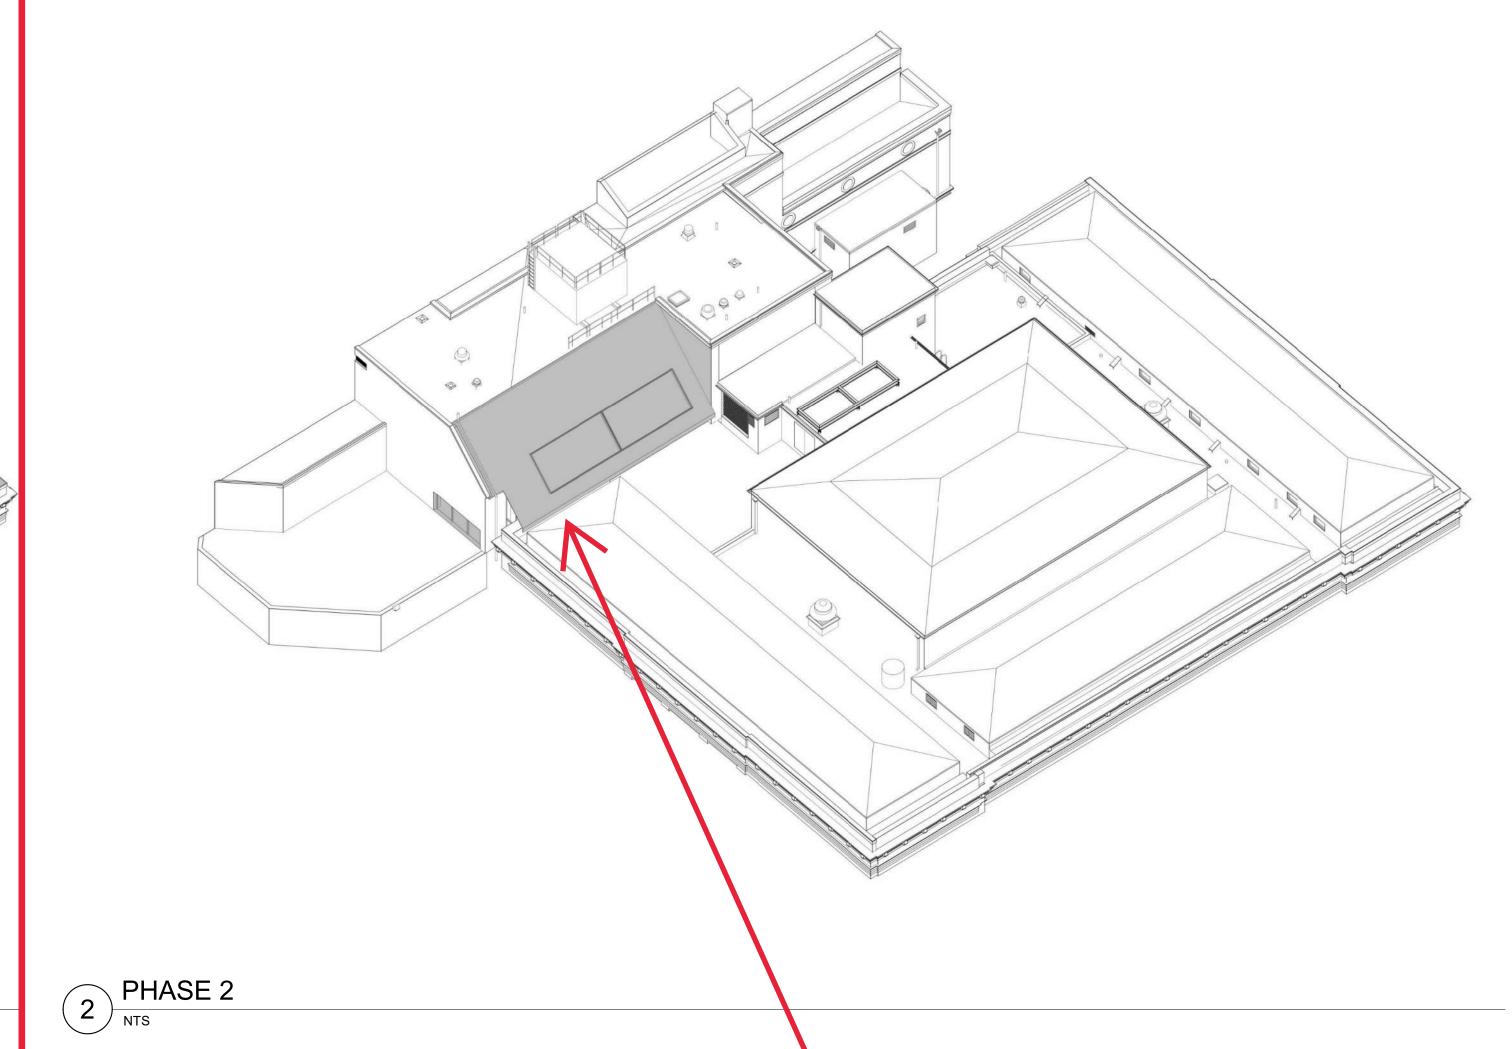
SITE PLAN

Drawing Title


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WHC, Area of Interest
Phase 2: Fuller
Conservation Lab Roof &
Skylight Replacement



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PHASING

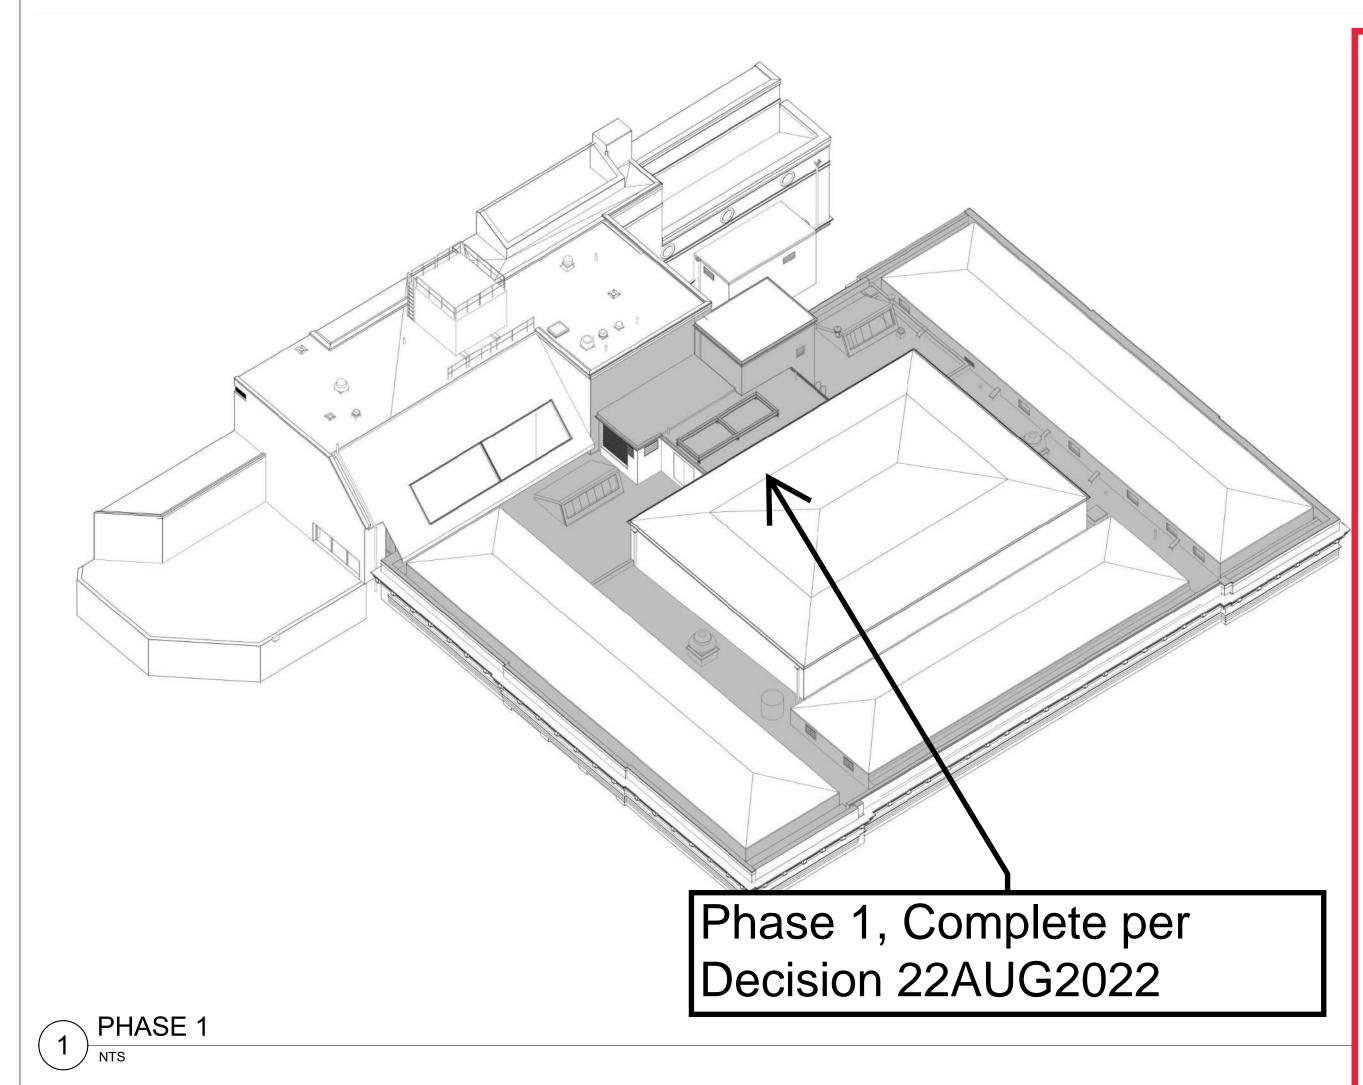Drawing Title

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G-101

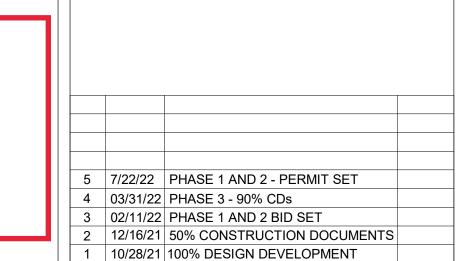Phase 3, Postponed & submitted at a later date.

3 PHASE 3

LEGEND


PHASING NOTES:

1. BUILDING MODEL AND SHADING SHOWN SCHEMATICALLY TO ILLUSTRATE GENERAL PHASING OF THE SCOPE OF WORK RELATED TO THE 1930s ROOF AND FULLER LAB ENVELOPE IMPROVEMENTS AND INTENDED FOR INFORMATIONAL PURPOSES ONLY; REFER TO DRAWINGS AND SPECIFICATIONS FOR COMPLETE SCOPE OF WORK.

APPROXIMATE WORK AREA BY PHASE

GENERAL: PROTECT ALL SURROUNDING FINISHES AND STRUCTURE TO REMAIN. SEQUENCE WORK OR PROVIDE SHORING TO MAINTAIN STABILITY OF STRUCTURE. REFER TO ADDITIONAL REQUIREMENTS IN SPECIFICATIONS.

HAZARDOUS MATERIALS: HAZARDOUS MATERIALS FOUND IN PROJECT AREA COORDINATE WITH ABATEMENT DRAWINGS AND REQUIREMENTS OF OWNER'S HAZARDOUS MATERIALS CONSULTANT.

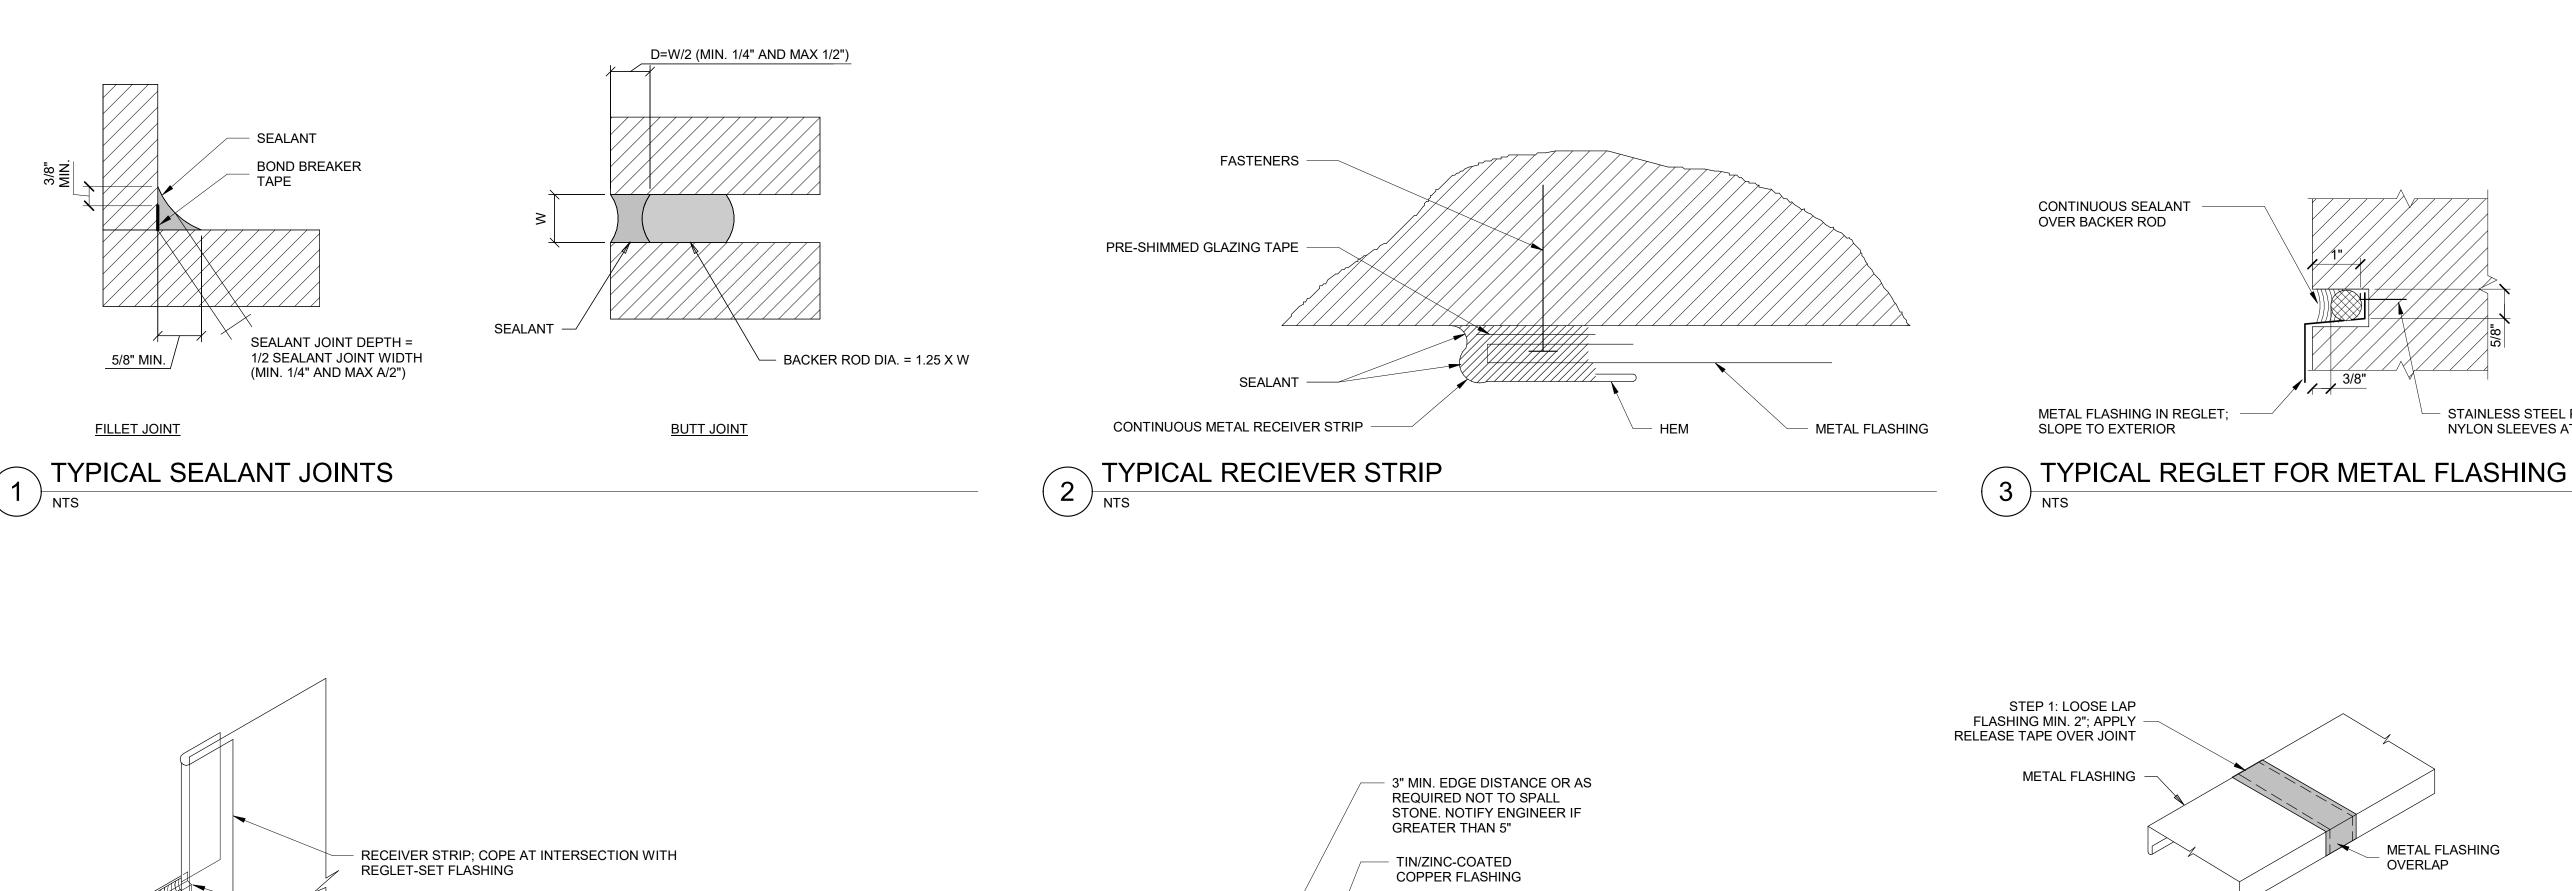

SELF-ADHERED HIGH-TEMPERATURE-

RESISTANT MEMBRANE UNDERLAYMENT

1. ALIGN BOTTOM OF HEM WITH EDGE OF STONE

CONTINUOUS TIN/ZINC-COATED -

5 TYPICAL FLASHING HEM

COPPER HOOK STRIP

1" OR SEE NOTE 1. -

(E) STONE

EXTEND REGLET UNDER RECEIVER STRIP TO WHERE


FLASHING STOPS


- LOCK JOINT

SEALANT AND BACKER ROD - CONTINUE UNDER METAL FLASHING

RECEIVER STRIP REGLET-SET FLASHING TRANSITION

REGLET-SET COUNTERFLASHING

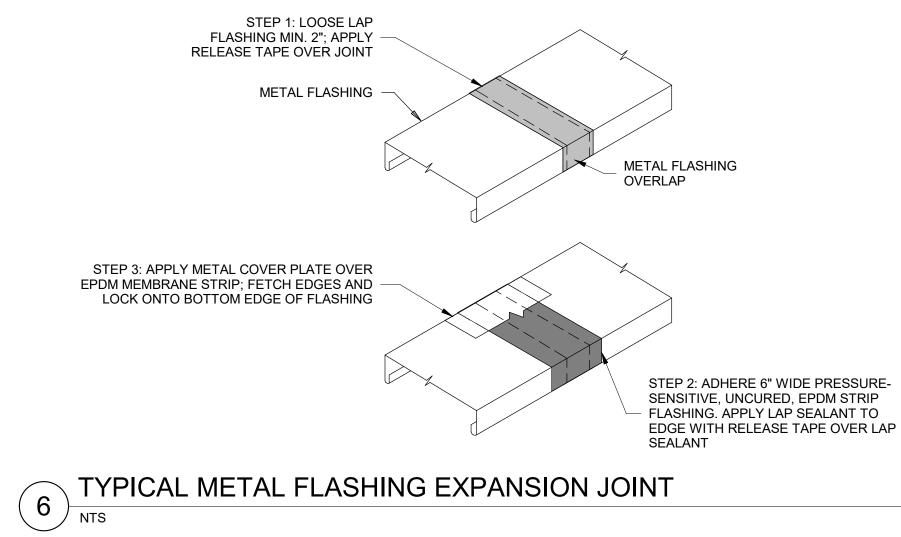

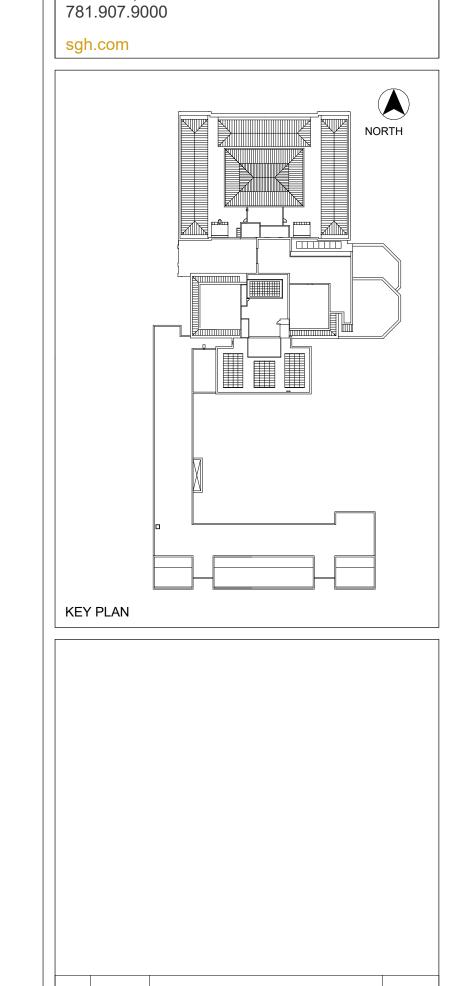

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STAINLESS STEEL PINS WITH NYLON SLEEVES AT 6" O.C.

5 | 7/22/22 | PHASE 1 AND 2 - PERMIT SET 4 03/31/22 PHASE 3 - 90% CDs 3 | 02/11/22 | PHASE 1 AND 2 BID SET 2 | 12/16/21 | 50% CONSTRUCTION DOCUMENTS

1930s Building Roof & Fuller Lab Envelope **Improvements**


> **WORCESTER ART MUSEUM** WORCESTER, MA

TYPICAL METAL DETAILS


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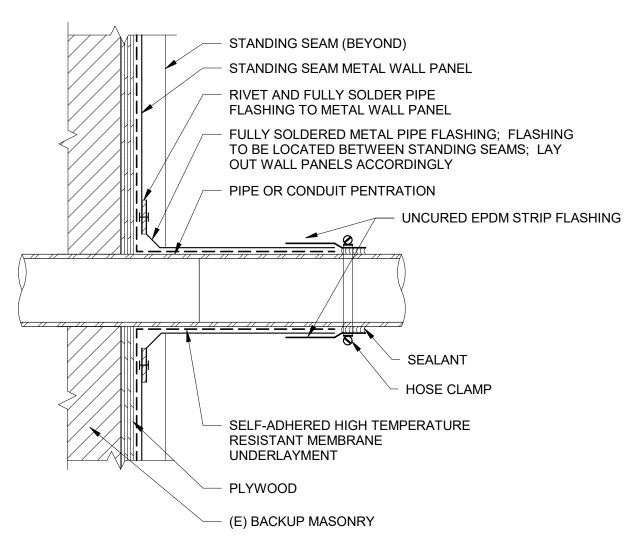


TYPICAL STANDING SEAM METAL WALL SYSTEM

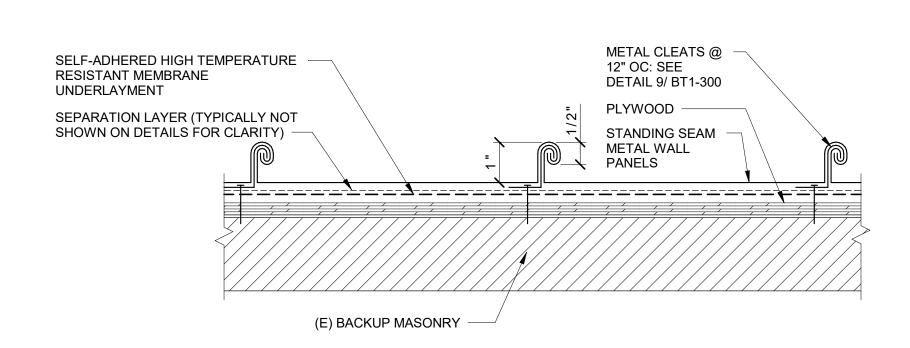


4 TYPICAL PARAPET COPING

NTS

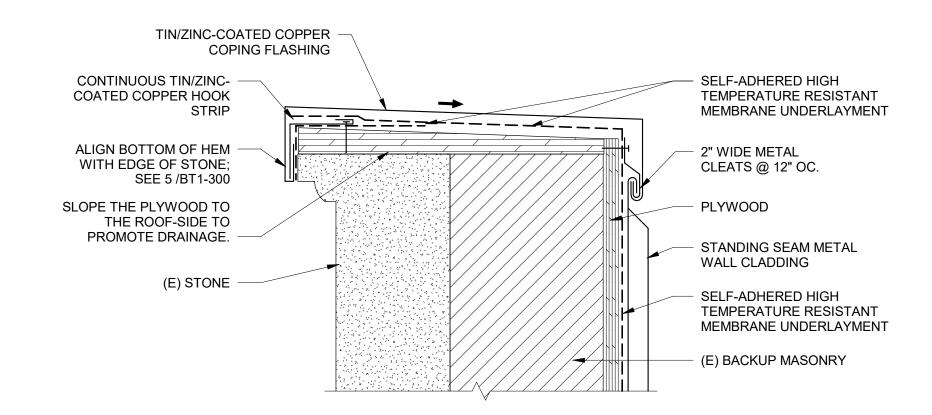


PENETRATION FLASHING AT STANDING SEAM WALL

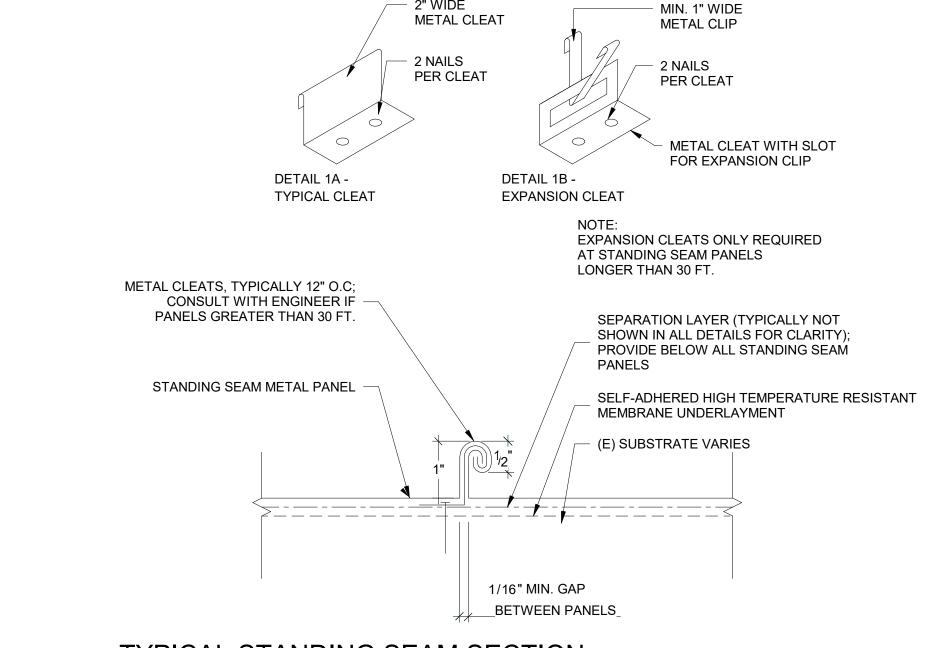


TYPICAL STANDING SEAM SECTION

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KEY PLAN

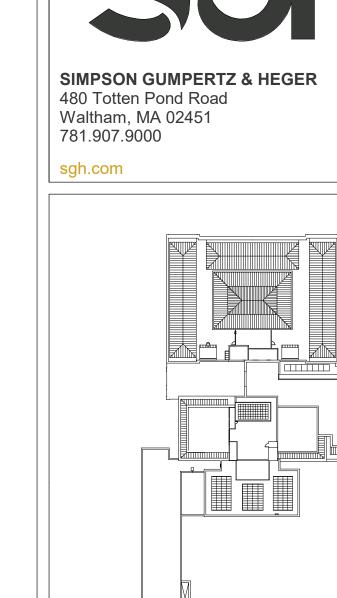

1930s Building Roof & Fuller Lab Envelope Improvements

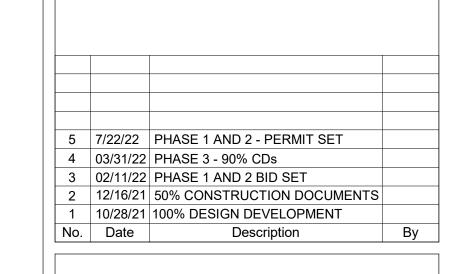WORCESTER ART MUSEUM WORCESTER, MA

Project


TYPICAL METAL DETAILS

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Drawing Title

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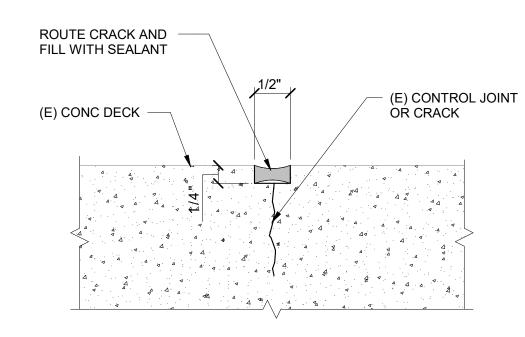
5 CORNER FLASHING

NOTES:


1. IF (E) DETERIORATED CONCRETE EXTENDS TO (E) REINFORCEMENT, REMOVE CONCRETE TO EXPOSE ALL SIDES OF REINFORCEMENT BAR. EXTEND REMOVAL ALONG BAR LENGTH TO THE EXTEND NECESSARY TO EXPOSE UNCORRODED REINFORCEMENT AND SURFACE OF SOUND UNCONTAMINATED CONCRETE.

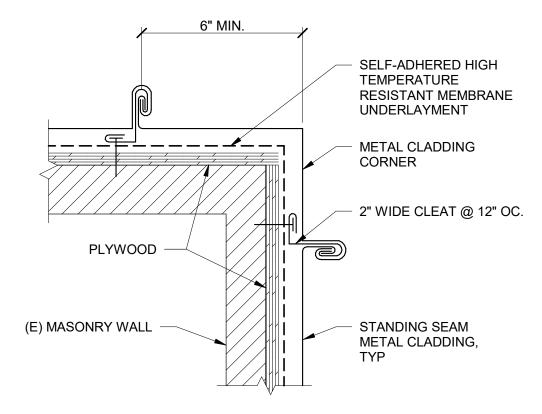2. TREAT ALL EXPOSED (E) REINFORCEMENT WITH ANTI-CORROSION COATING. 3. NOTIFY ENGINEER OF SEVERELY DETERIORED OR CORRODED REINFORCEMENT. ASSUME ADDED LAP SPLICE BARS OF MECHANICAL COUPLERS ARE REQUIRED TO ENGAGE (E) REINFORCEMENT TO MAINTAIN CONTINUITY.

CONCRETE DECK REPAIR



CONCRETE CRACK REPAIR

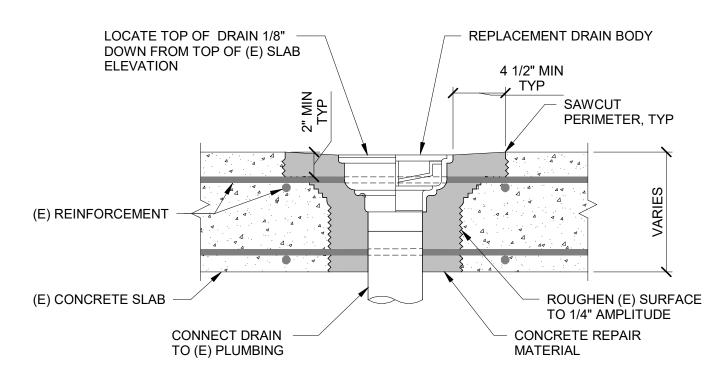

NOTES:

1. LOCATE (E) REINFORCEMENT OR EMBEDDED CONDUIT. DO NOT CUT, NICK OR DAMAGE (E) REINFORCING BARS. CONTRACTOR MAY CUT THROUGH (E) WWR TO INSTALL NEW DRAINS, IF PRESENT.


DRAIN BODY REPLACEMENT SECTION

NTS



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1930s Building Roof & Fuller Lab Envelope **Improvements**

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TYPICAL CONCRETE **REPAIR DETAILS**

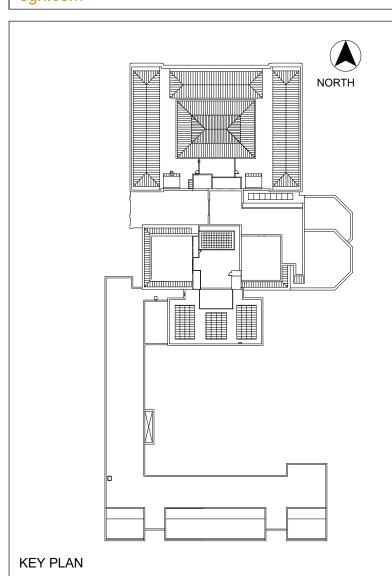Project No. Checked 7/22/2022 KEM/BBS/MAW As indicated








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KEY PLAN

5 7/22/22 PHASE 1 AND 2 - PERMIT SET 4 03/31/22 PHASE 3 - 90% CDs 3 02/11/22 PHASE 1 AND 2 BID SET 2 | 12/16/21 | 50% CONSTRUCTION DOCUMENTS 1 | 10/28/21 | 100% DESIGN DEVELOPMENT

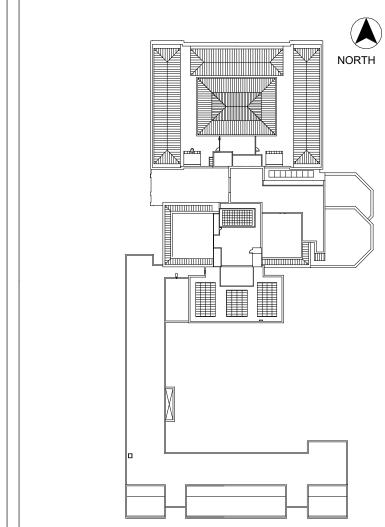1930s Building Roof & Fuller Lab Envelope **Improvements**

Description

WORCESTER ART MUSEUM WORCESTER, MA

Project

PHASE 1

ROOF REMOVAL PLAN

Drawing Title

Project No.	Checked	Date
210608.00	CCW	7/22/2022
Drawn	Approved	Scale
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	Drawing I	

R1-100

REMOVE AND DISPOSE OF (E) BUILT-UP ROOF SYSTEM. REFER TO DETAIL 1/R1-300. REMOVE AND DISPOSE OF (E) METAL FLASHING AND UNDERLAYMENT O REMOVE AND DISPOSE OF (E) DRAIN REMOVE AND DISPOSE OF (E) SKYLIGHT, FLASHING, FRAME, AND CURB REMOVE AND DISPOSE OF (E) BALLASTED EPDM ROOF SYSTEM REMOVE AND DISPOSE OF (E) METAL FLASHING AND UNDERLAYMENT AT BUILT-IN GUTTERS. REFER TO DETAIL 2/ R1-300. (E) SECURITY CAMERA ON METAL STRUT ATTACHMENT AND CONDUIT/WIRING; RELOCATE AS REQUIRED TO COMPLETE WORK. COORDINATE WITH OWNER. REMOVE AND DISPOSE OF (E) MECHANICAL CURB AND VENT. OUTLINE OF (E) MECHANICAL DUCTWORK AND EQUIPMENT TO BE LOCATIONS SHOWN.

REMOVE AND DISPOSE OF (E) CURB TO ROOF REMOVE AND \ R1-300 / DISPOSE OF (E) CURB TO ROOF (E) COVERED SKYLIGHT TO REMAIN (E) COVERED SKYLIGHT TO REMAIN (E) SKYLIGHT TO REMAIN REMOVE AND DISPOSE OF (E) DUNNAGE REMOVE AND DISPOSE OF (E) HUNG GUTTERS AND DOWNLEADERS; TYP. BOTH — (E) MECHANICAL ROOM ROOF (ELEV 37'- 3") R1-300 1930s ROOF 1930s ROOF (ELEV 44'-9") (ELEV 44'-9") REMOVE AND DISPOSE OF (E) 2 R3-200 (E) MECHANICAL ROOM PRECAST CONCRETE HIGH ROOF PAVERS ON CURB (ELEV APPROX. 64'-0") R1-200 (E) BALLASTED EPDM ROOF OVERHANG OF (E) FULLER LAB ROOF ABOVE (E) DOWNLEADER FROM HIGH SYSTEM (ELEV 66'-1")

MÉCHANICAL ROOM. REROUTE DURING

CONSTRUCTION; TYP. BOTH SIDES

NORTH

(E) COVERED SKYLIGHT

1930s ROOF CORNICE REMOVE AND DISPOSE OF REMOVE AND DISPOSE OF (E) INTERIOR FINISHES (E) CURTAIN WALL FROM FLOOR TO CEILING (E) WINDOW; SEE PHASE 2 DRAWINGS - FULLER LAB (ELEV 36'-1")

(E) CORNICE BELOW; TYP.

REMOVE AND DISPOSE OF (E)

COPPER FLASHING OVER

Phase 1, Complete per Decision 22AUG2022

1930 ROOF REMOVAL PLAN

FULLER LAB EXTERIOR WALL PART PLAN 1/4" = 1'-0"

REMOVED. COORDINATE WITH MECHANICAL DRAWINGS. 1930 ROOF SCOPE OF WORK: I. REMOVE AND DISPOSE OF (E) BUILT-UP ROOF SYSTEM TO (E) CONCRETE DECK; ASSUME THE (E) ROOF SYSTEM IS A FIVE-PLY COAL TAR PITCH ROOF, REMOVE AND DISPOSE OF (E) FLASHING IN MASONRY WALLS AT PERIMETERS, PENETRATIONS, AND RISING WALLS. (E) THROUGH-WALL FLASHING TO REMAIN; UNHOOK AND LIFT (E) METAL FLASHING AS

REQUIRED TO COMPLETE ROOFING WORK. PROTECT METAL FLASHING FROM DAMAGE AND DO NOT CUT. REMOVE AND DISPOSE OF (E) BALLASTED EPDM MECHANICAL ROOM ROOF TO (E) CONCRETE DECK.

LEGEND

REMOVE AND DISPOSE OF (E) METAL FLASHING AND UNDERLAYMENT TO (E) WOOD BLOCKING AND FRAMING AT THE (E) BUILT-IN GUTTERS.

REMOVE AND DISPOSE OF (E) METAL FLASHING AND UNDERLAYMENT AT LOCATIONS SHOWN ON THE DRAWINGS.

REMOVE AND DISPOSE OF (E) ROOF DRAINS. COORDINATE WITH PLUMBING DRAWINGS.

RELOCATE SECURITY CAMERAS AS REQUIRED TO COMPLETE WORK. COORDINATE TEMPORARY LOCATIONS AND ALL SHUTDOWNS WITH OWNER'S SECURITY.

REMOVE AND DISPOSE OF (E) METAL EXHAUST VENTS AND VENT CURBS TO ROOF DECK AT LOCATIONS SHOWN. COORDINATE WITH MECHANICAL DRAWINGS.

REMOVE AND DISPOSE OF (E) INTERIOR FULLER LAB FINISHES AT


NOTES:

1. PROVIDE TEMPORARY PROTECTION AS REQUIRED DURING REMOVALS TO THE PROTECTION AS REPORTED DURING REMOVALS TO THE PROTECTION AS REPORTED DURING REMOVALS MAINTAIN WEATHER-TIGHTNESS AND STRUCTURAL INTEGRITY. DIMENSIONS, RELATIVE ELEVATIONS, SCALE, ETC. ARE SHOWN FOR

OWNER'S HAZARDOUS MATERIALS CONSULTANT.

REFERENCE ONLY. CONTRACTOR TO VERIFY ALL DIMENSIONS IN FIELD PRIOR TO BIDDING. HAZARDOUS MATERIALS: HAZARDOUS MATERIALS FOUND IN PROJECT

AREA. COORDINATE WITH ABATEMENT DRAWINGS AND REQUIREMENTS OF

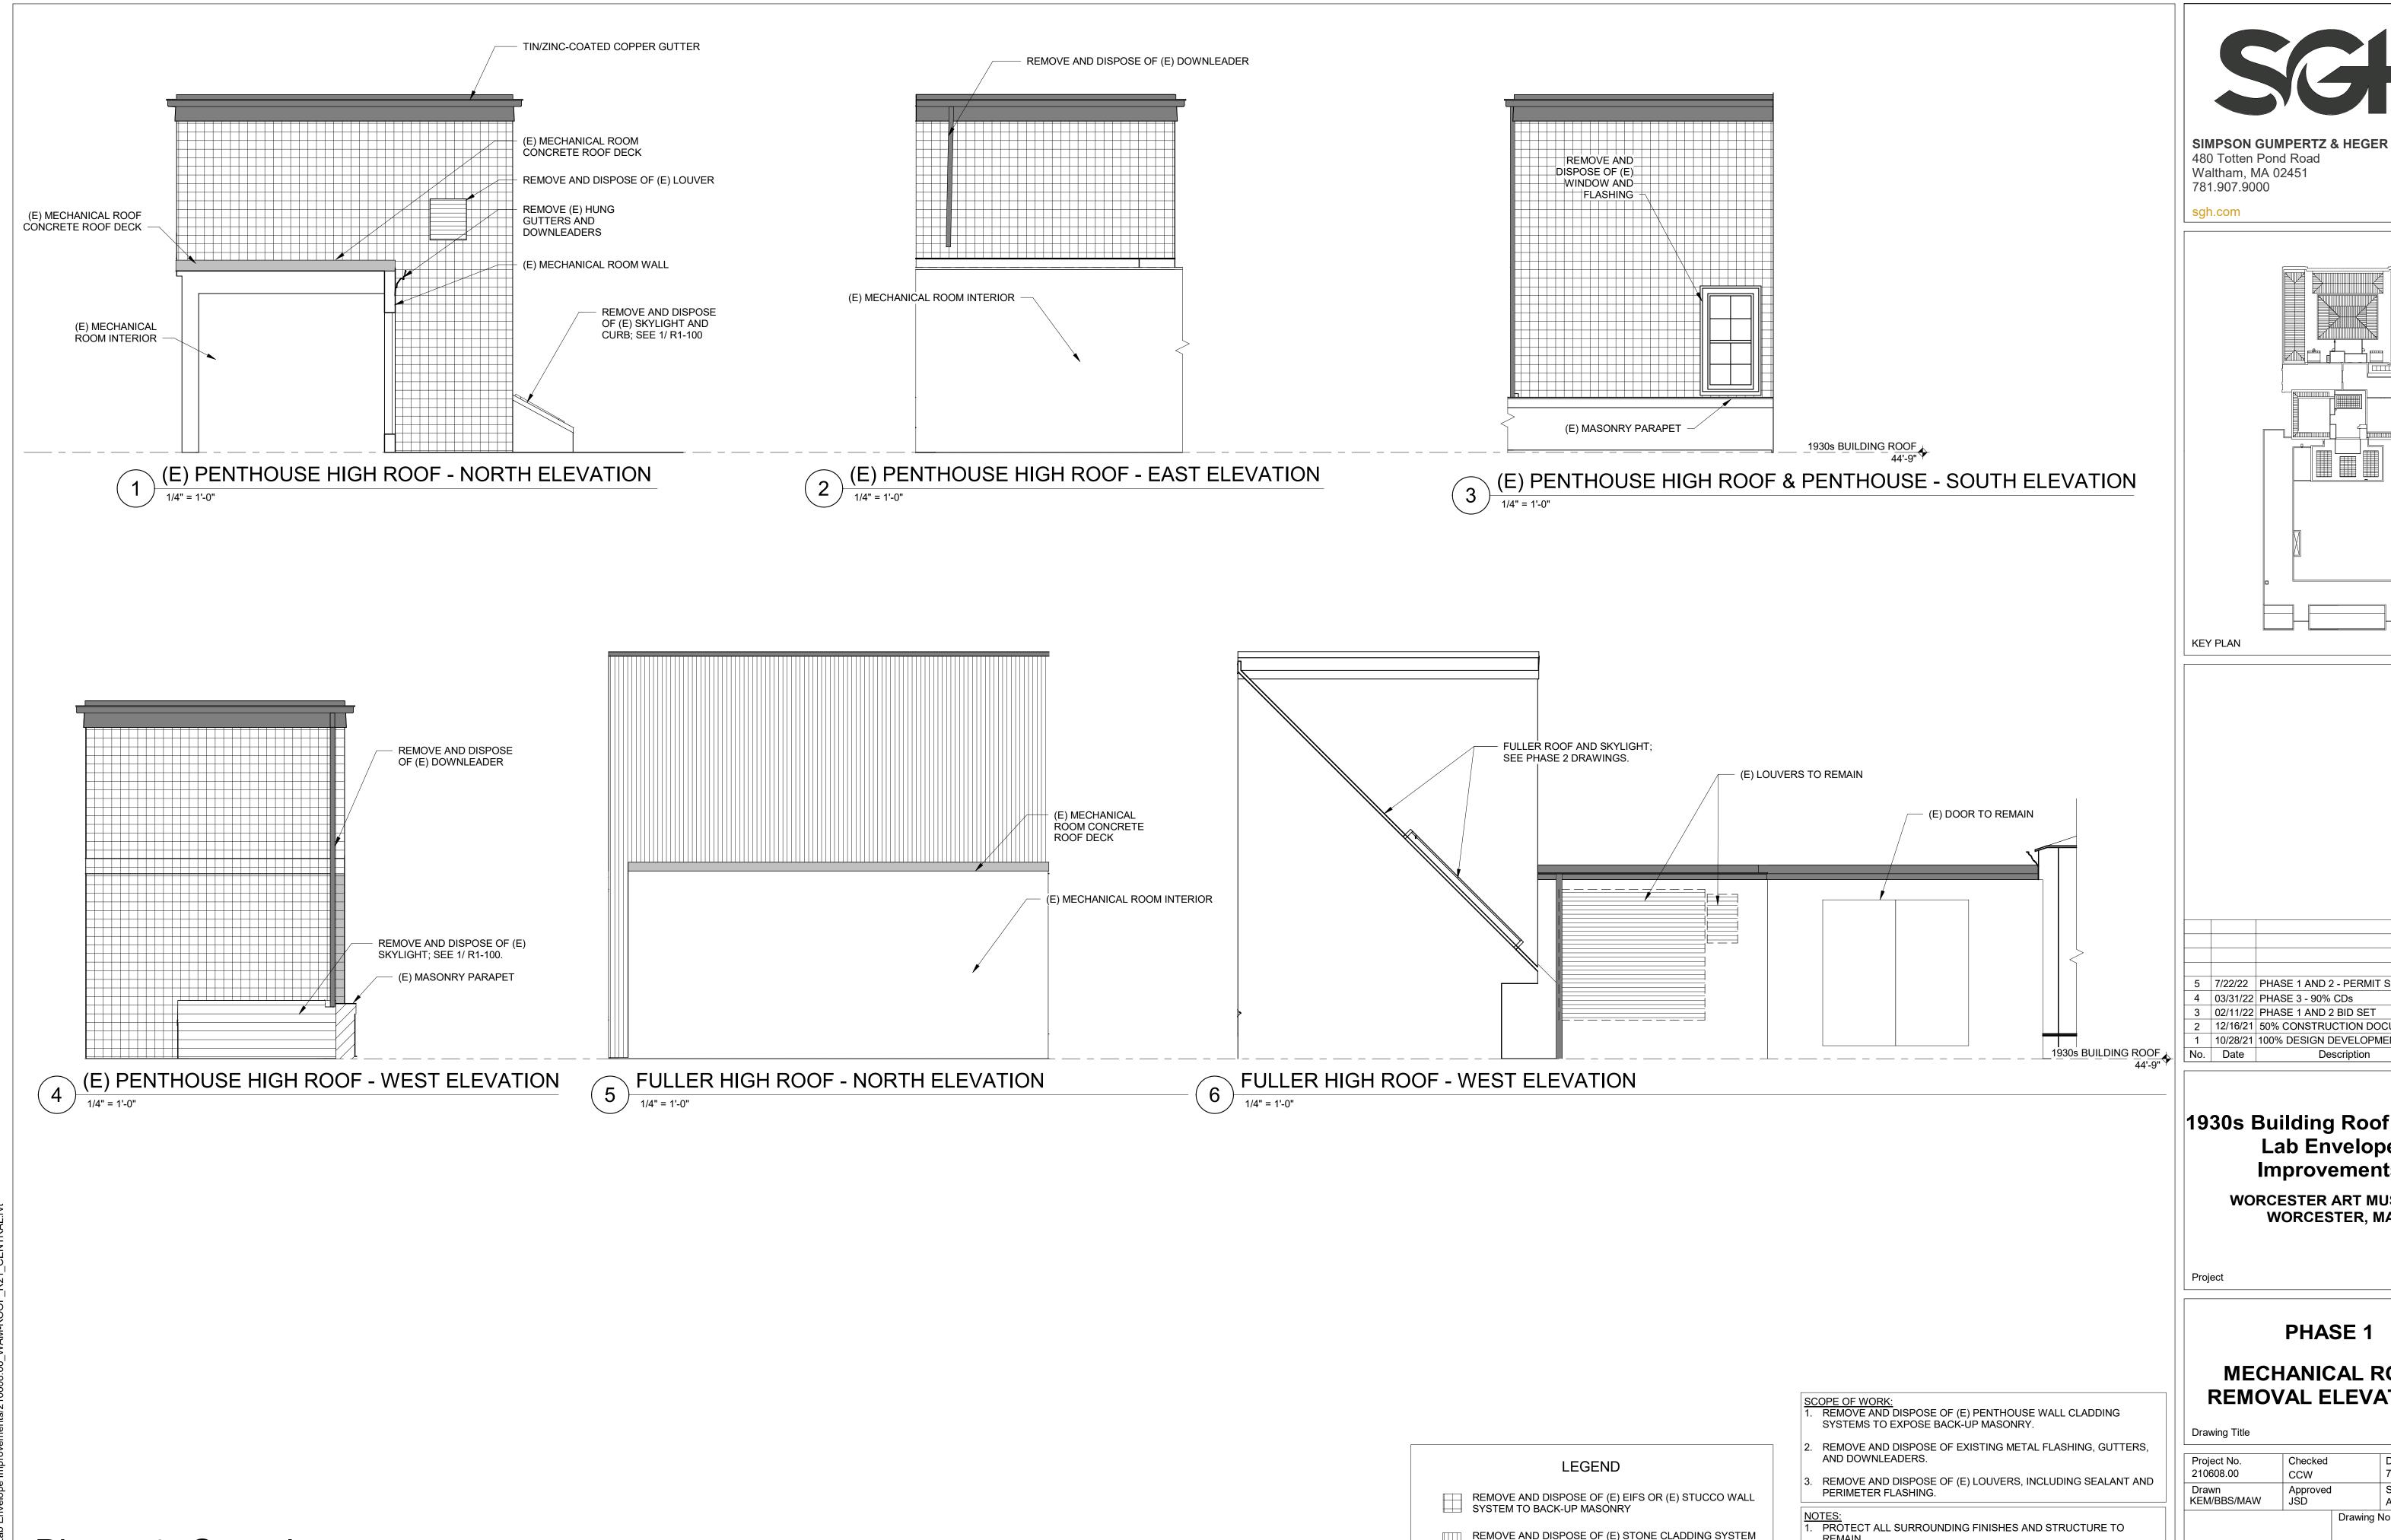

TO BACK-UP MASONRY

REMOVE AND DISPOSE OF (E) METAL FLASHING OR GUTTERS

5 7/22/22 PHASE 1 AND 2 - PERMIT SET 12/16/21 50% CONSTRUCTION DOCUMENTS 10/28/21 100% DESIGN DEVELOPMENT

1930s Building Roof & Fuller Lab Envelope **Improvements**

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MECHANICAL ROOM **REMOVAL ELEVATIONS**

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DIMENSIONS, MEMBER SIZES, EXISTING FRAMING

DIMENSIONS IN FIELD PRIOR TO BIDDING.

CONSULTANT.


CONFIGURATIONS, RELATIVE ELEVATIONS, SCALE, ETC. ARE

SHOWN FOR REFERENCE ONLY. CONTRACTOR TO VERIFY ALL


HAZARDOUS MATERIALS: HAZARDOUS MATERIALS FOUND IN PROJECT AREAS. COORDINATE WITH ABATEMENT DRAWINGS AND

REQUIREMENTS OF OWNER'S HAZARDOUS MATERIALS

R1-200

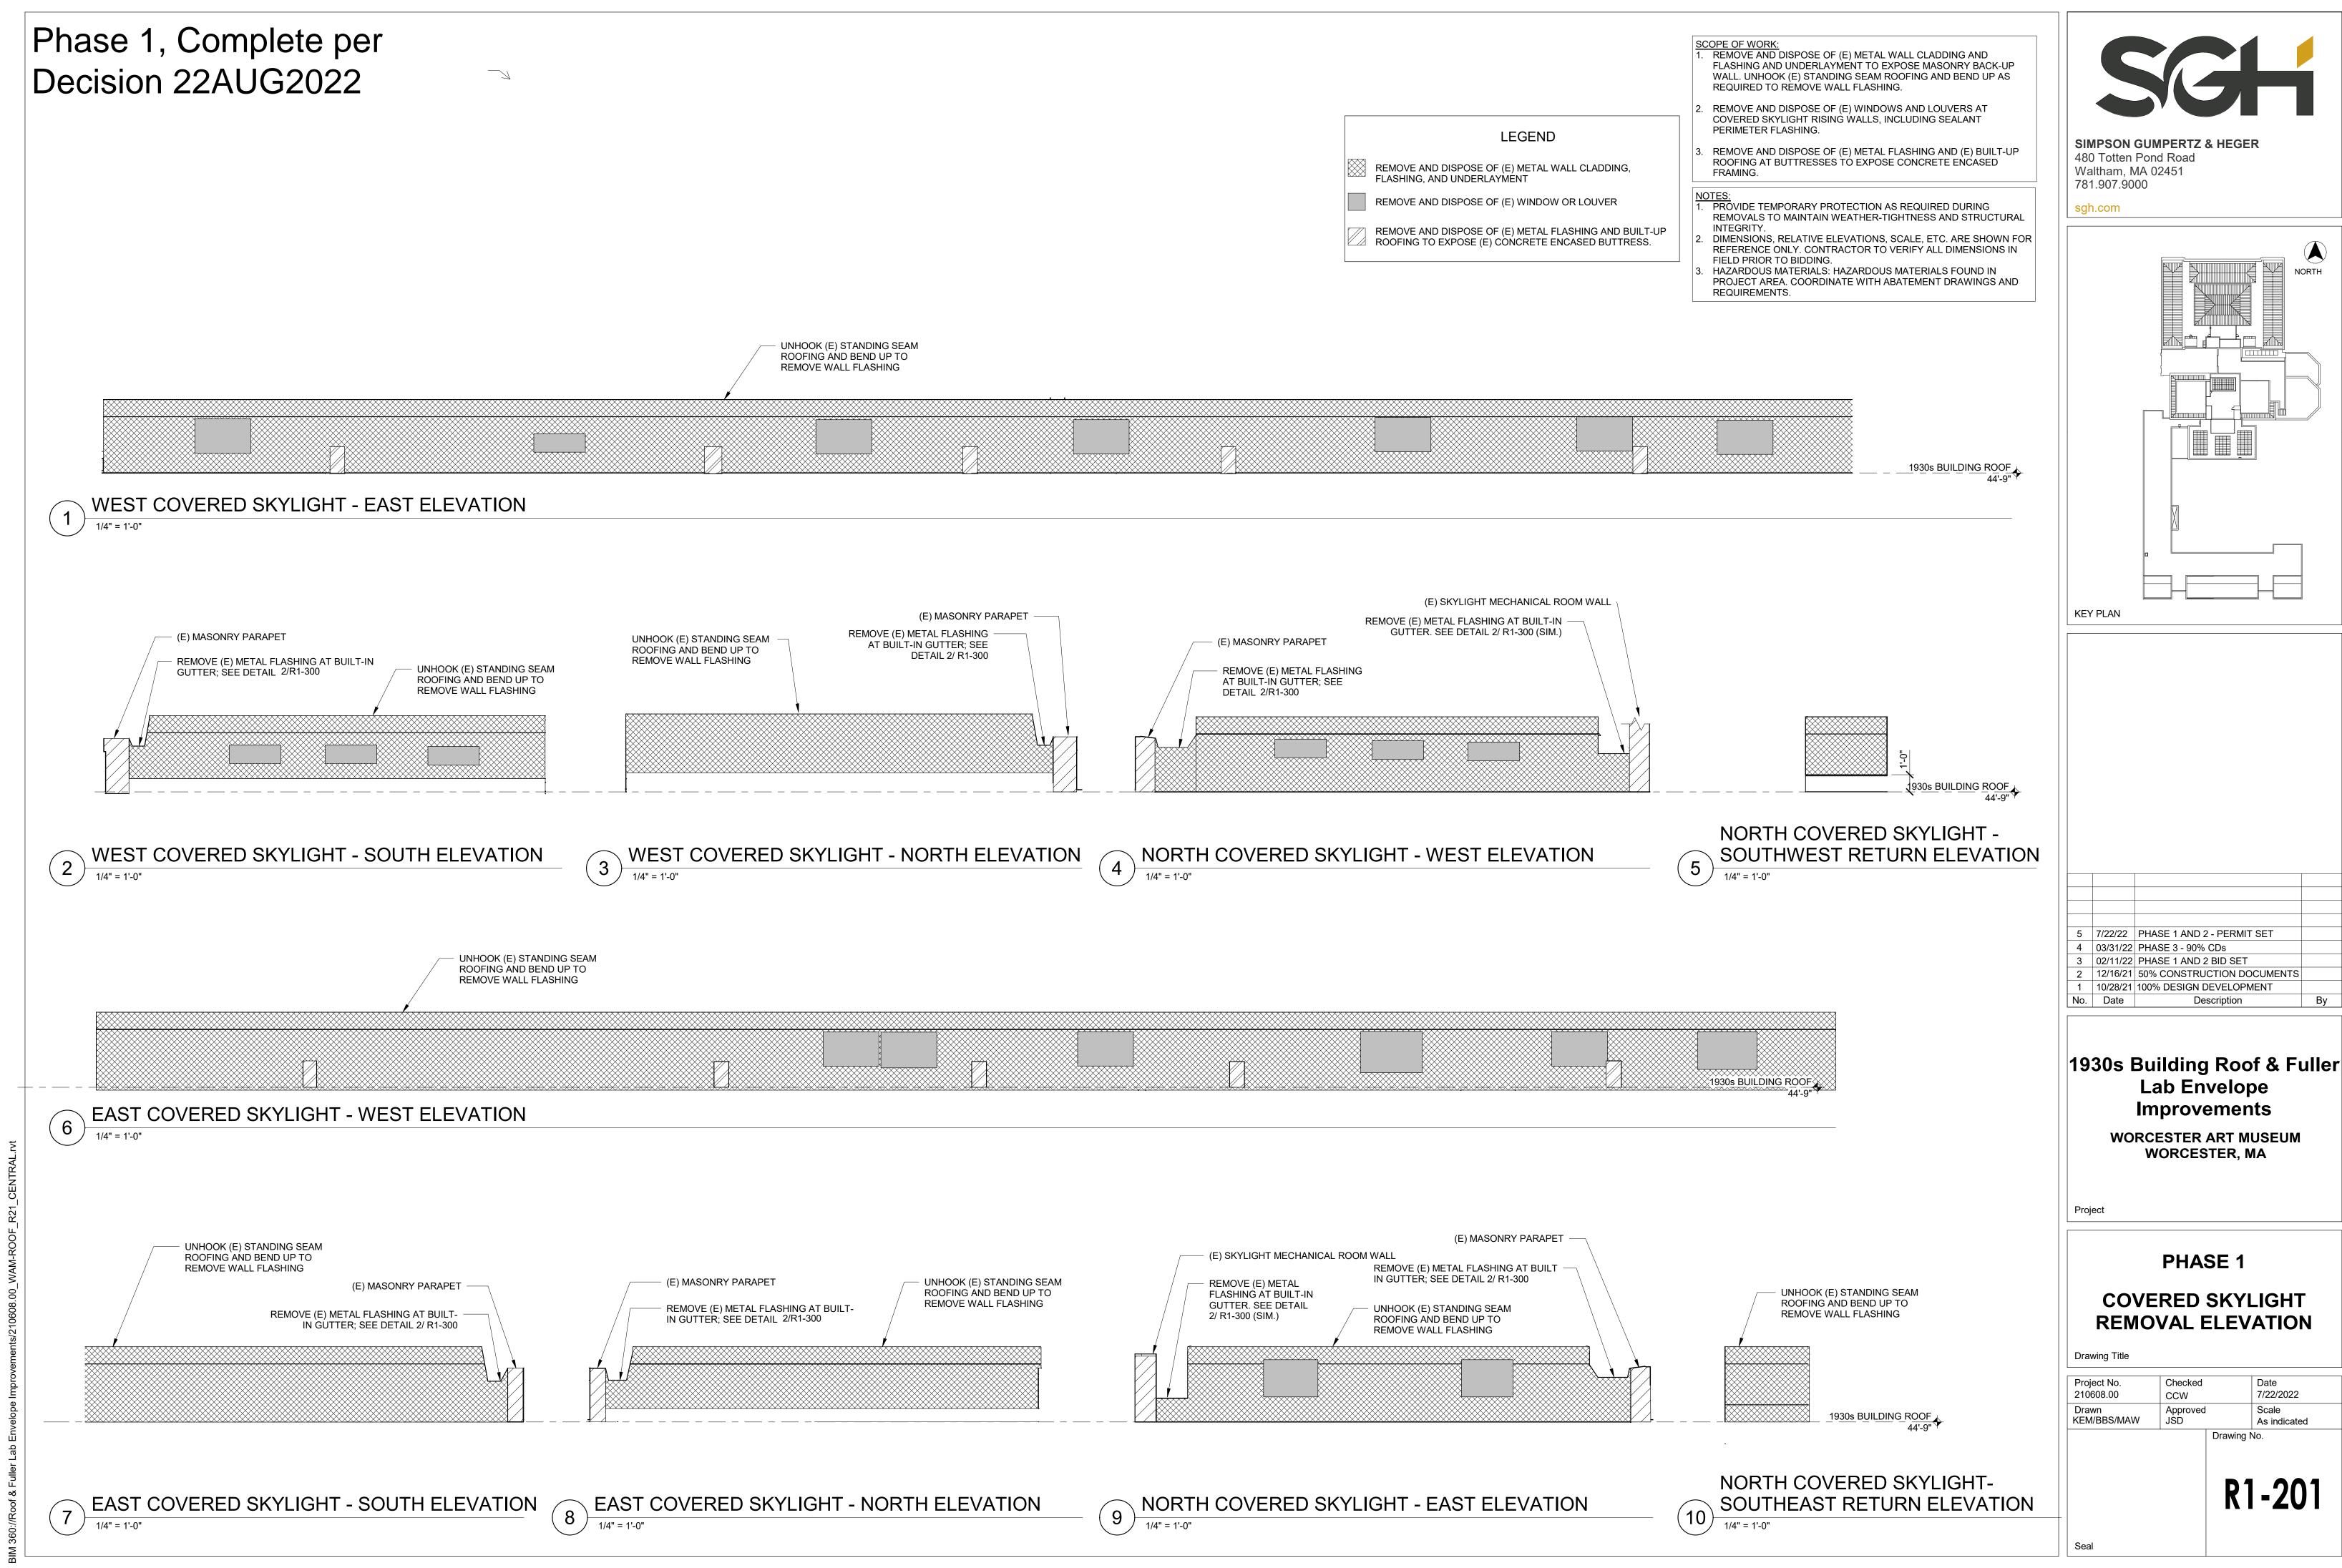


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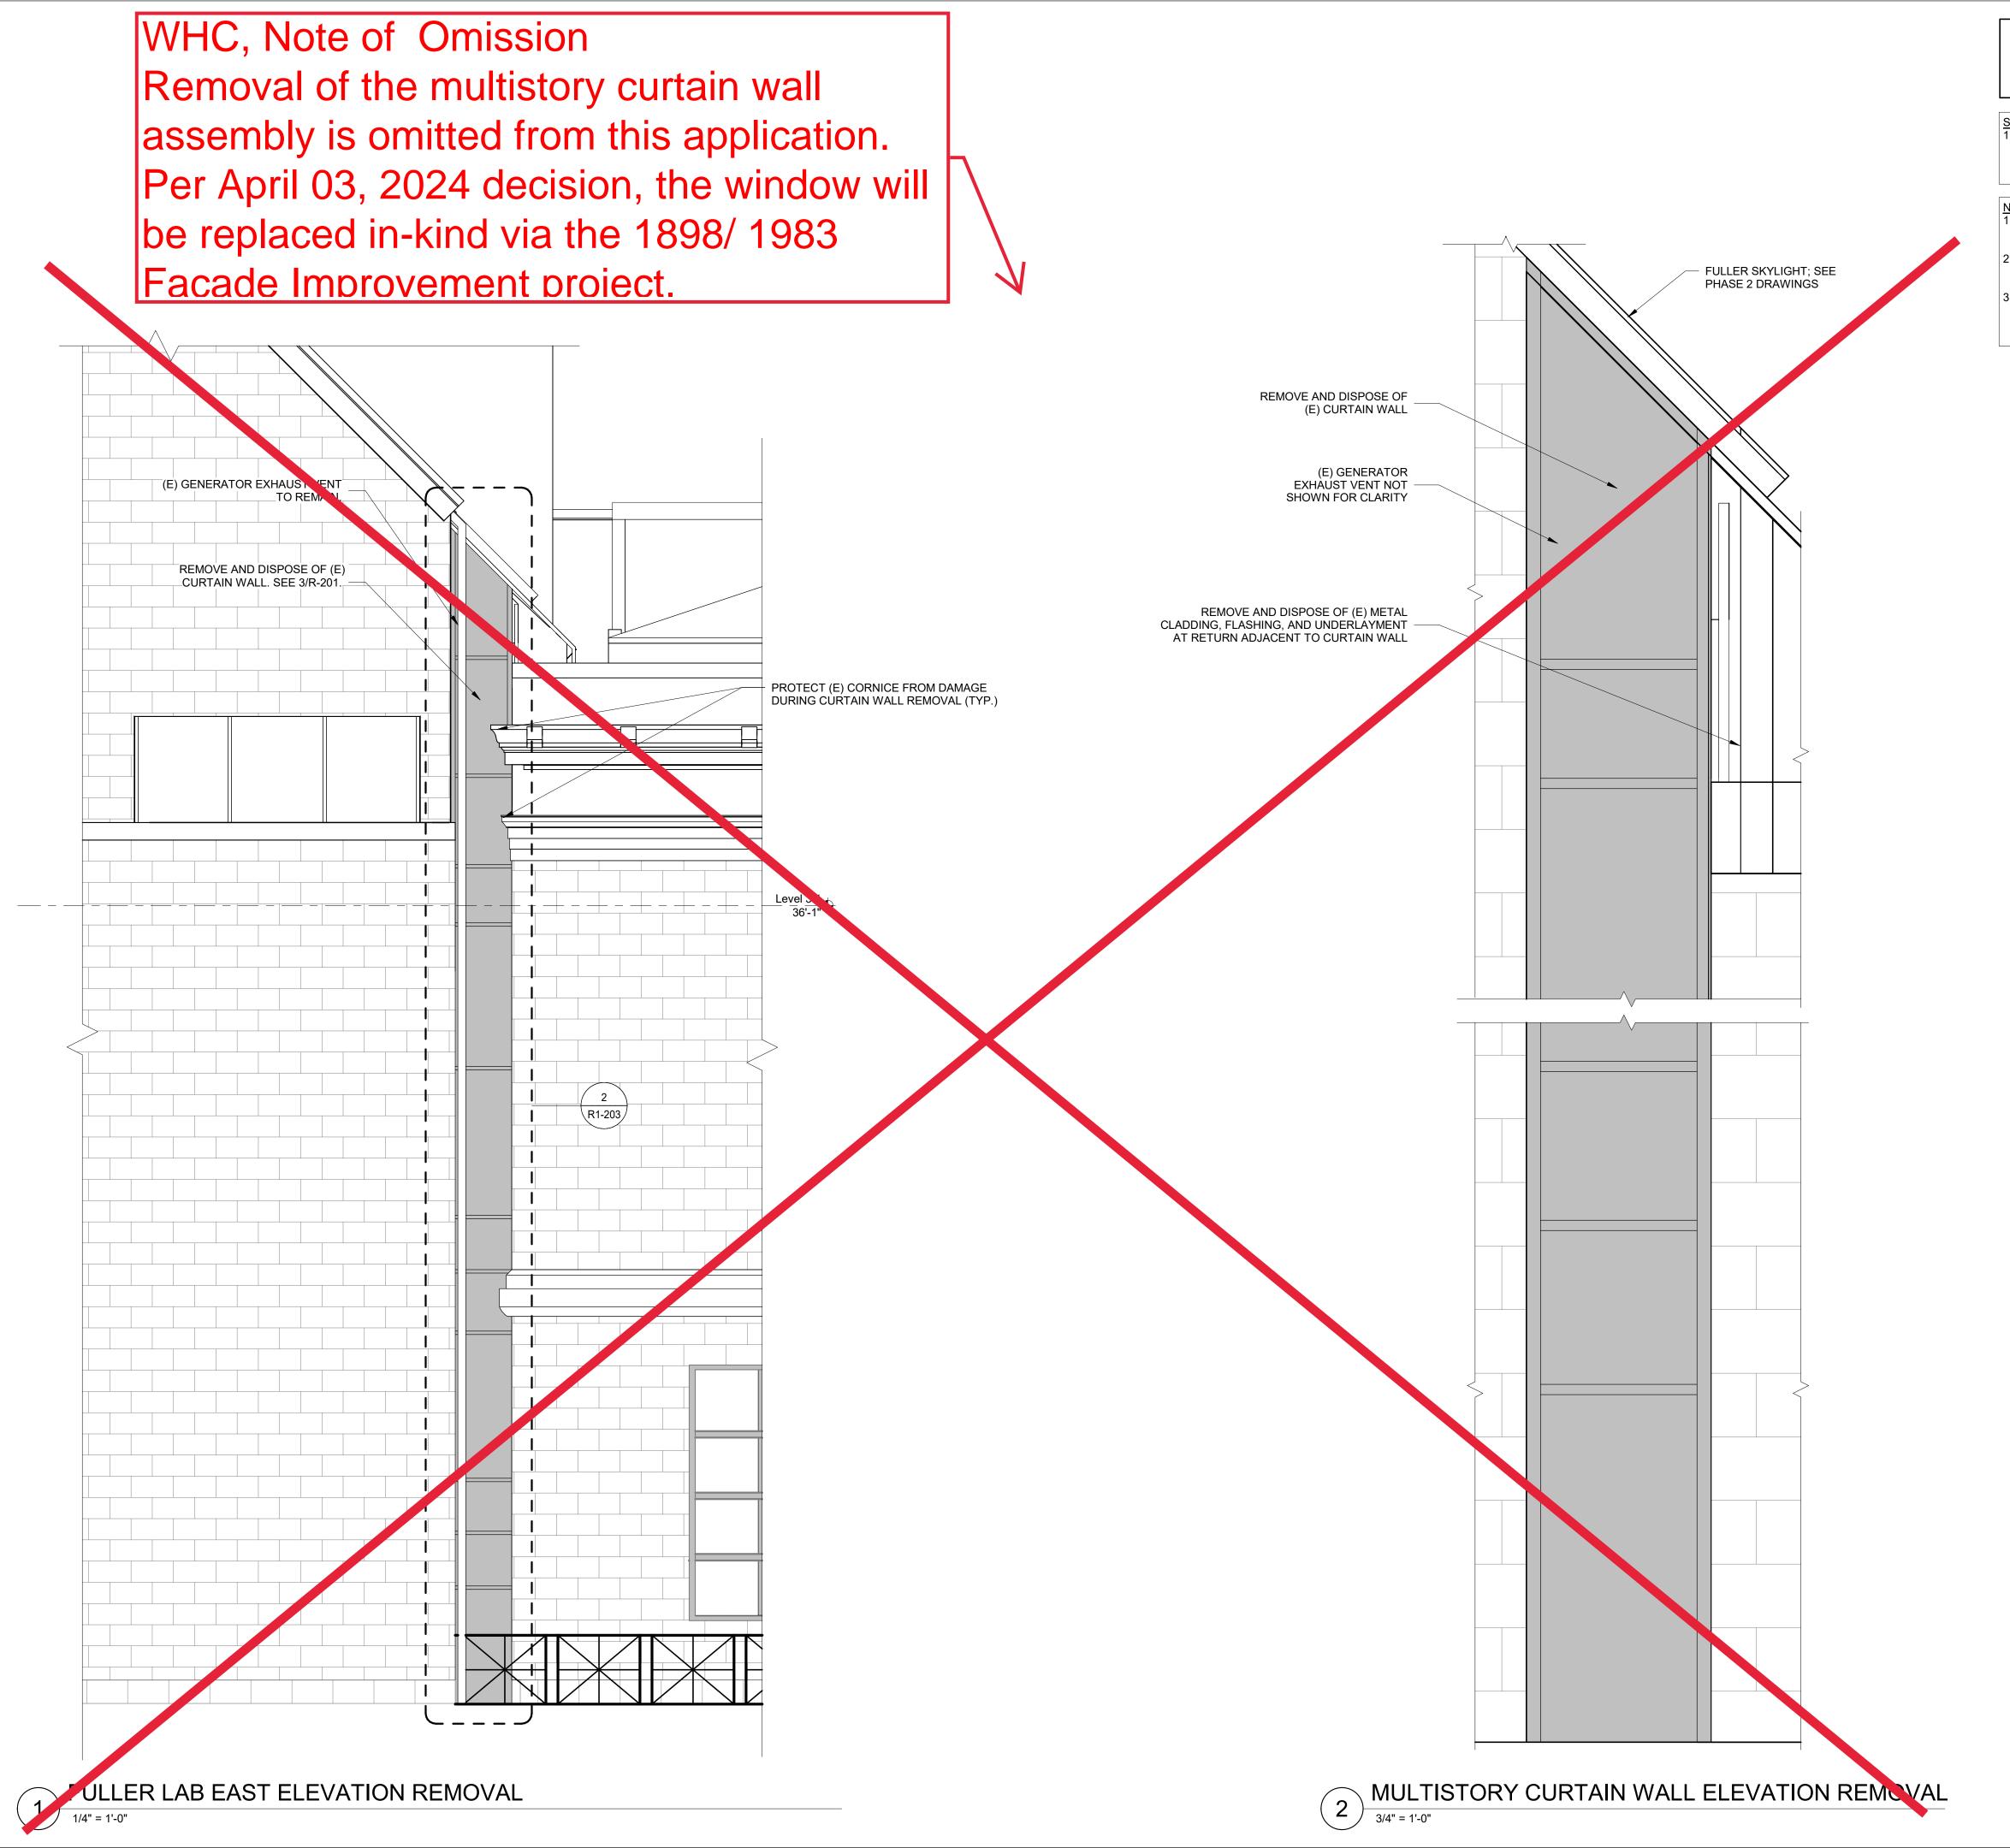
> **WORCESTER ART MUSEUM WORCESTER, MA**

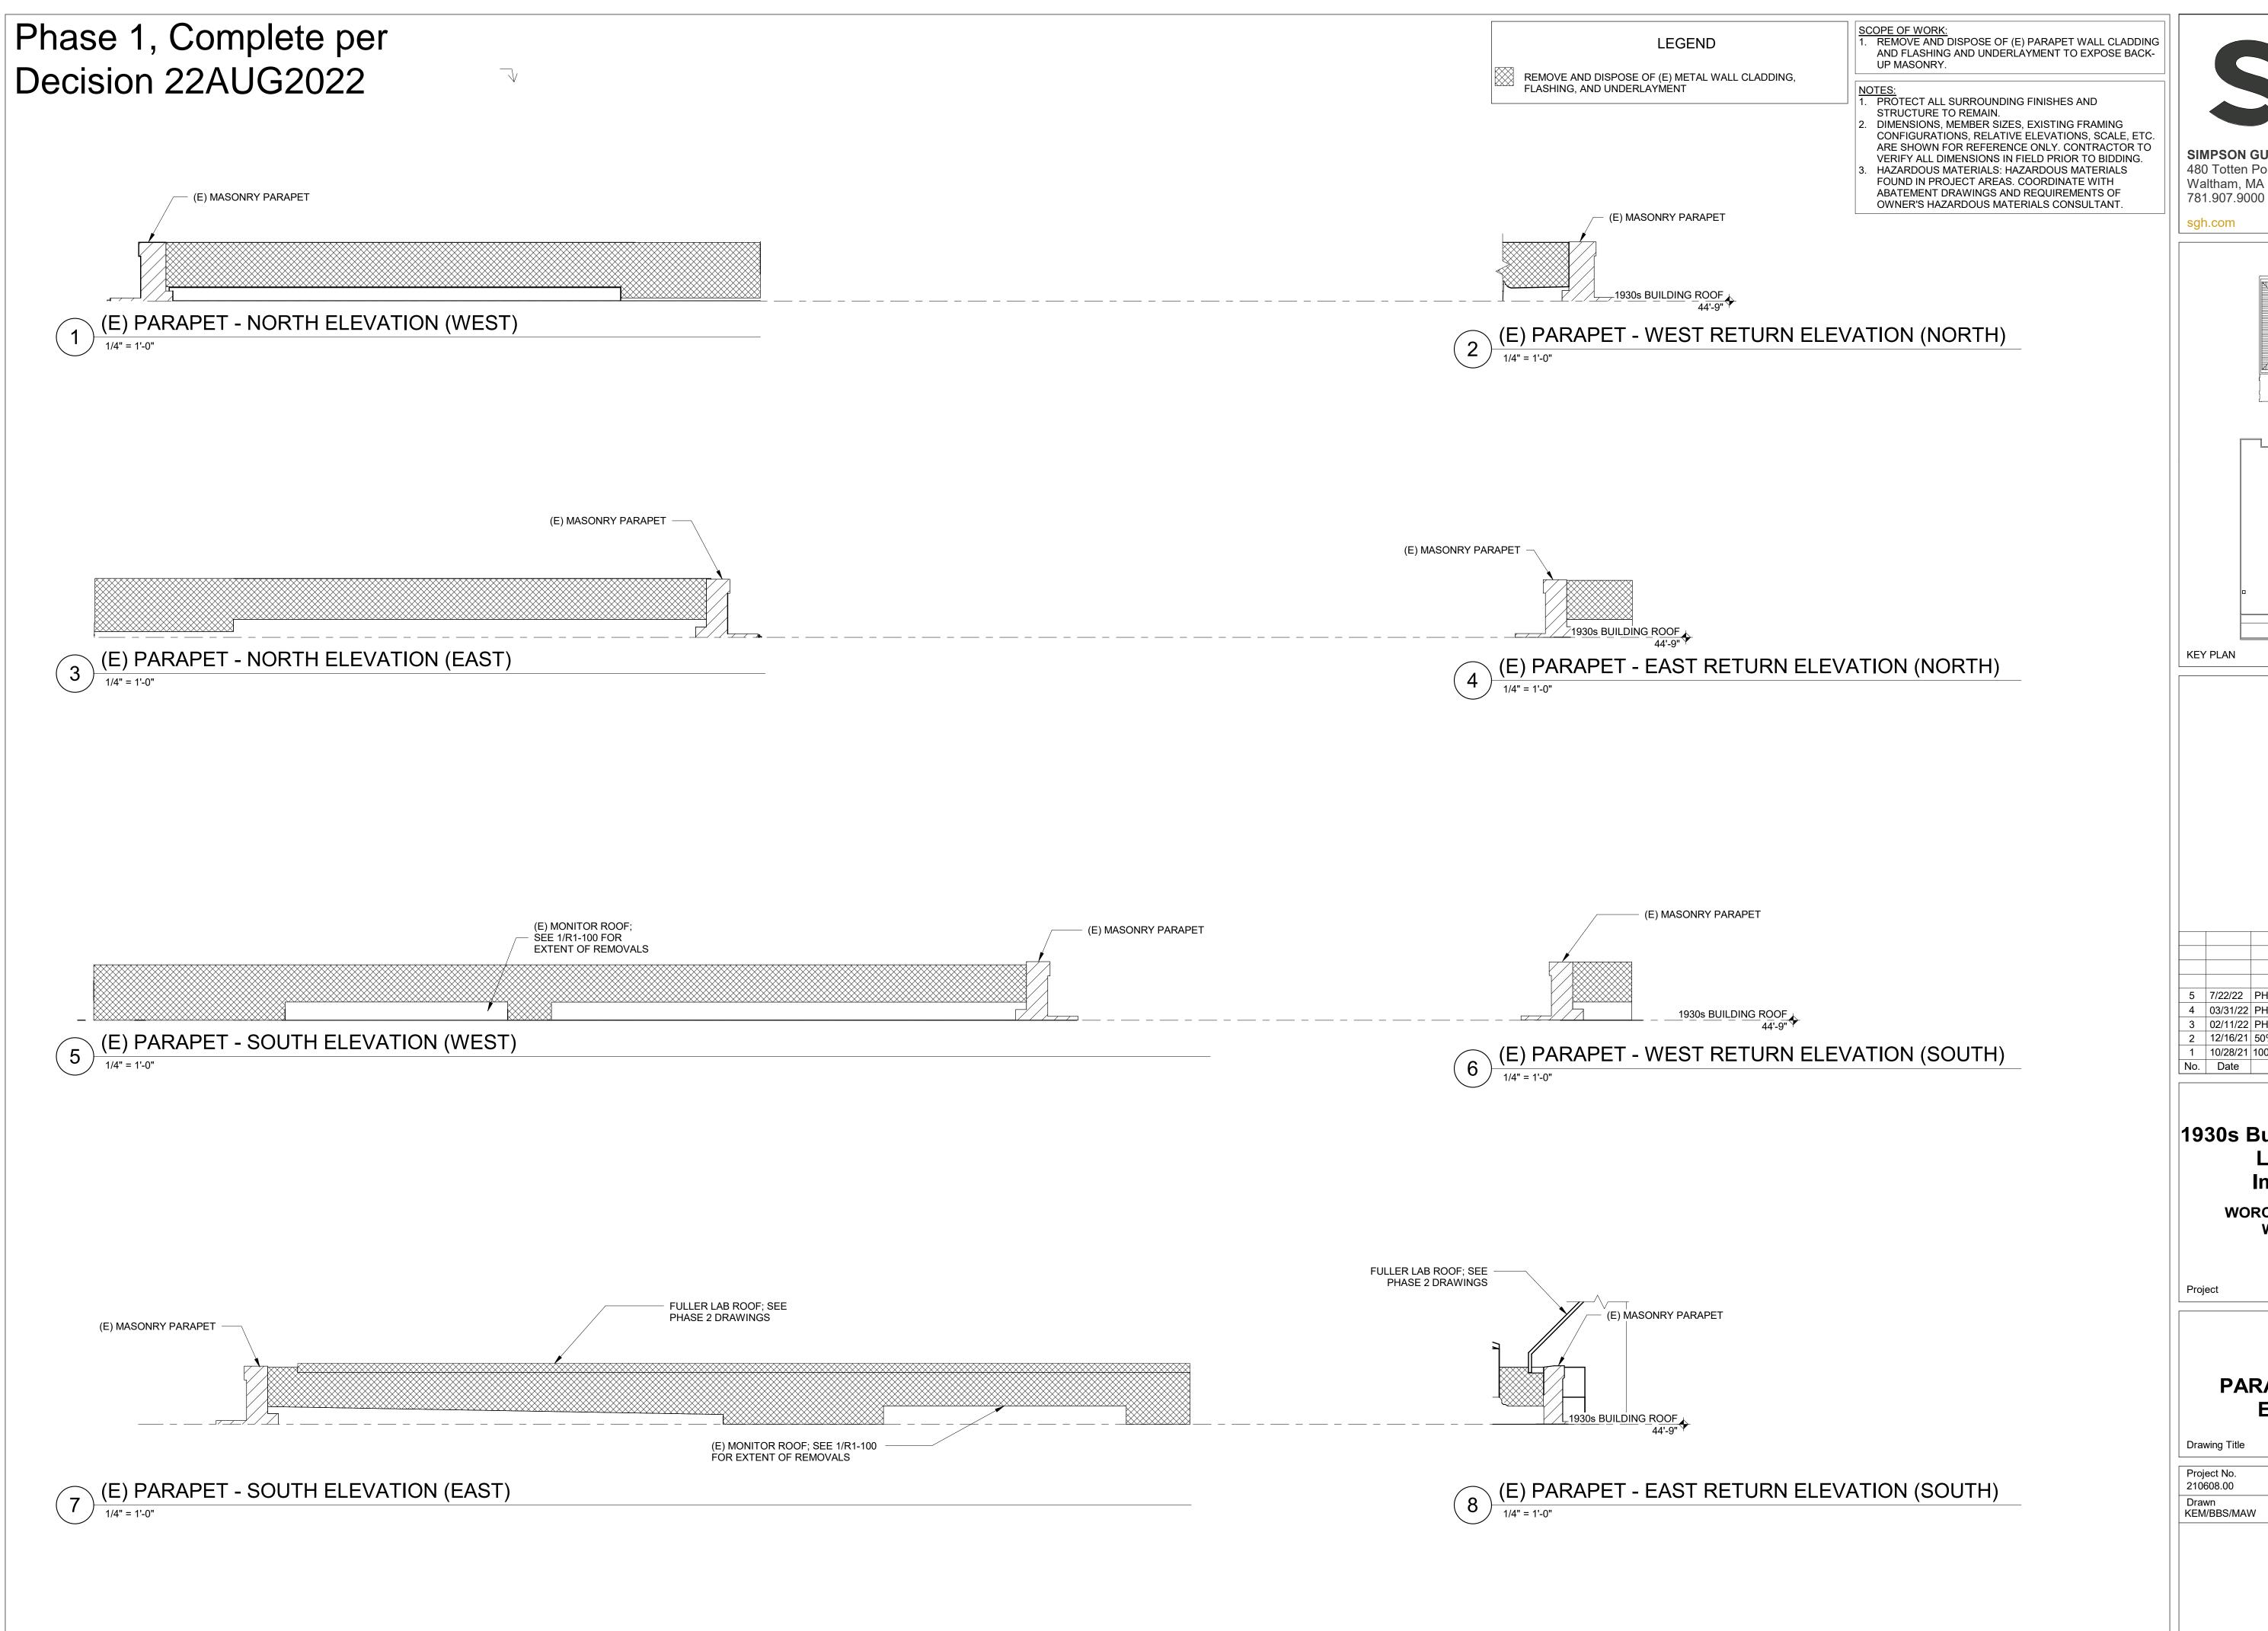PHASE 1 PARAPET REMOVAL

ELEVATIONS

Drawing Title
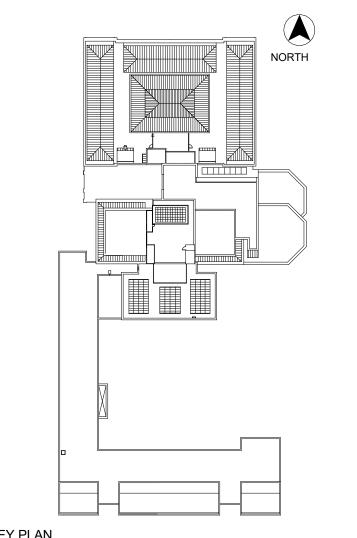
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210608.00	CCW	7/22/2022
Drawn	Approved	Scale
KEM/BBS/MAW	JSD	As indicated
	Drawing I	



REMOVE AND DISPOSE OF (E) FENESTRATION ASSEMBLY

SCOPE OF WORK:

1. REMOVE AND DISPOSE OF (E) CURTAIN WALL AT FULLER, INCLUDING SEALANT, PERIMETER FLASHING, SPANDREL INSULATION, BACK PAN ASSEMBLY, FIRESAFING AT FLOOR LINES,

NOTES:


1. PROVIDE TEMPORARY PROTECTION AS REQUIRED DURING REMOVALS TO MAINTAIN WEATHER-TIGHTNESS AND STRUCTURAL

- DIMENSIONS, RELATIVE ELEVATIONS, SCALE, ETC. ARE SHOWN FOR REFERENCE ONLY. CONTRACTOR TO VERIFY ALL DIMENSIONS IN FIELD PRIOR TO BIDDING.
- HAZARDOUS MATERIALS: HAZARDOUS MATERIALS FOUND IN PROJECT AREA. COORDINATE WITH ABATEMENT DRAWINGS AND REQUIREMENTS OF OWNER'S HAZARDOUS MATERIALS CONSULTANT.



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5	7/22/22	PHASE 1 AND 2 - PERMIT SET	
4	03/31/22	PHASE 3 - 90% CDs	
3	02/11/22	PHASE 1 AND 2 BID SET	
2	12/16/21	50% CONSTRUCTION DOCUMENTS	
1	10/28/21	100% DESIGN DEVELOPMENT	
No.	Date	Description	

1930s Building Roof & Fuller Lab Envelope **Improvements**

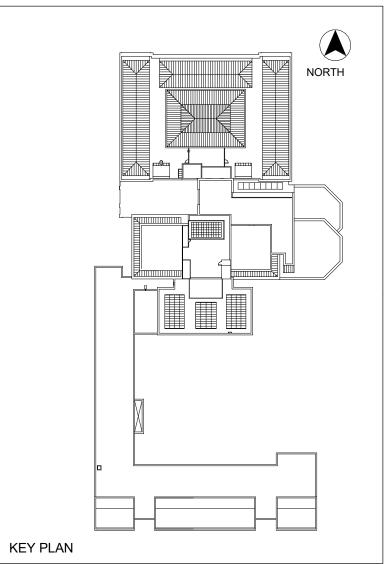
WORCESTER ART MUSEUM WORCESTER, MA

PHASE 1

FULLER LAB REMOVAL ELEVATIONS

Project No.	Checked	Date
210608.00	CCW	7/22/2022
Drawn KEM/BBS/MAW	Approved JSD	Scale As indicated
	Drawing	No.


R1-203

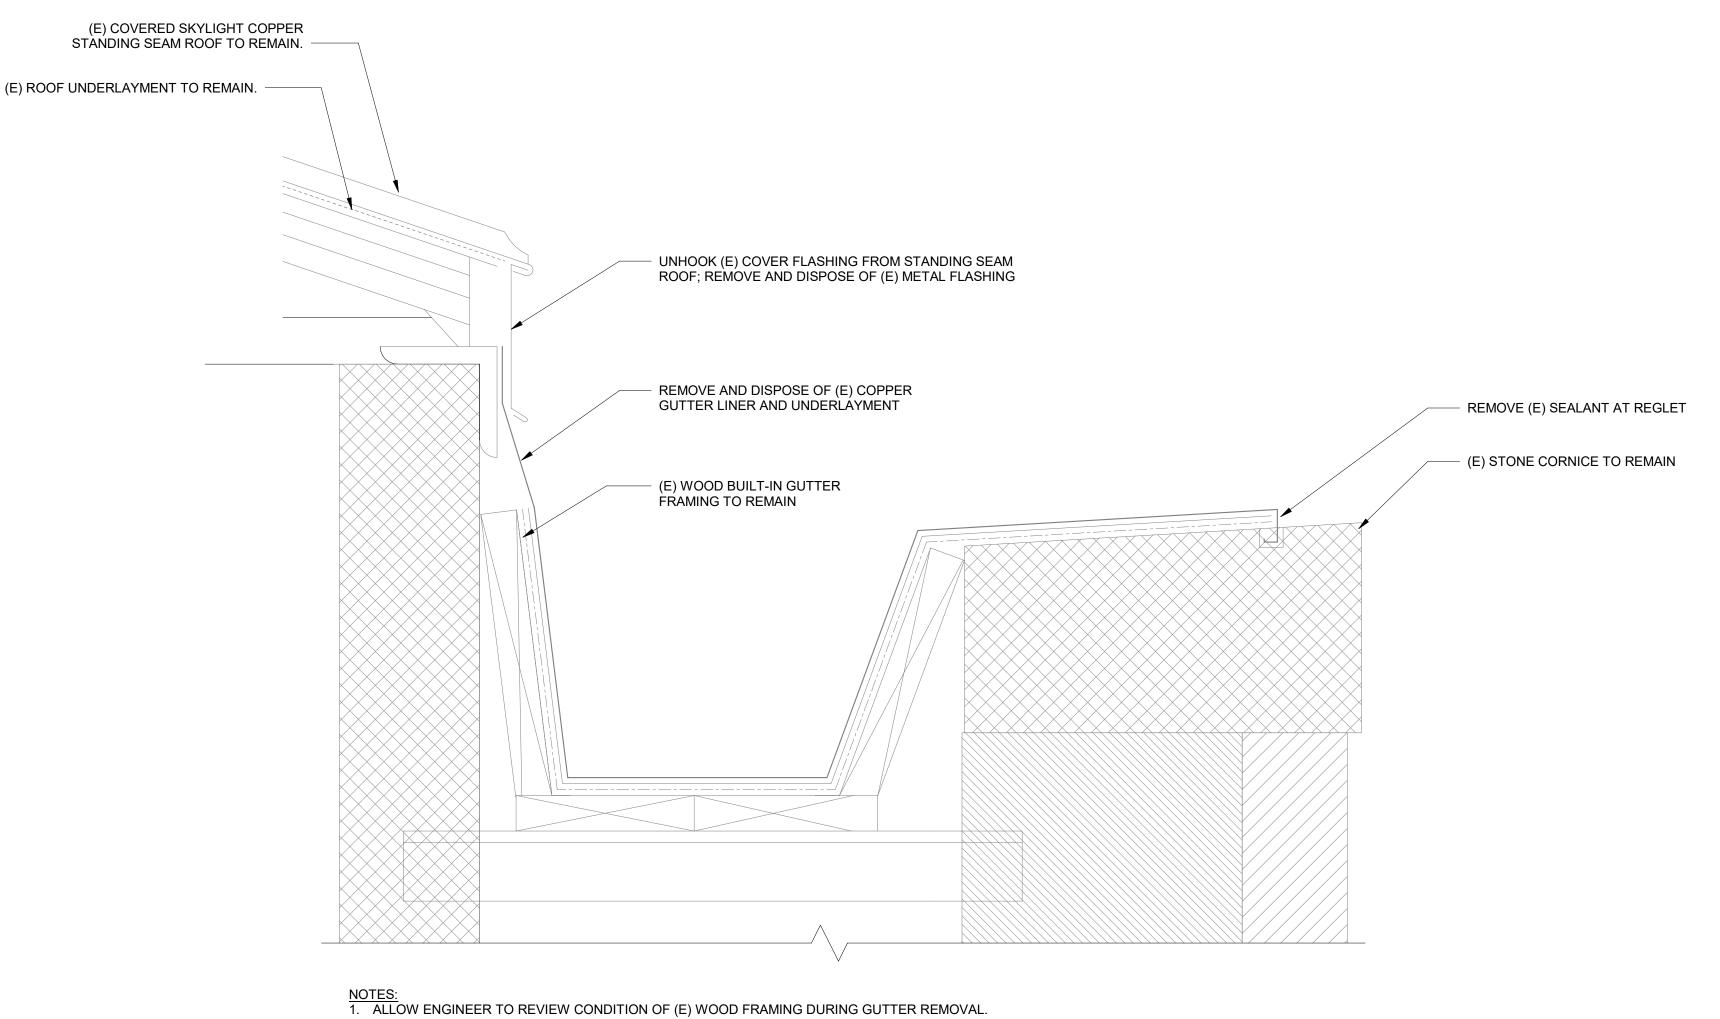

(E) BUILT IN GUTTER AT ROOF EDGE

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5	7/22/22	PHASE 1 AND 2 - PERMIT SET
4	. ,,	PHASE 3 - 90% CDs
3	02/11/22	PHASE 1 AND 2 BID SET
2	12/16/21	50% CONSTRUCTION DOCUMENTS
1	10/28/21	100% DESIGN DEVELOPMENT
No.	Date	Description

1930s Building Roof & Fuller Lab Envelope **Improvements**

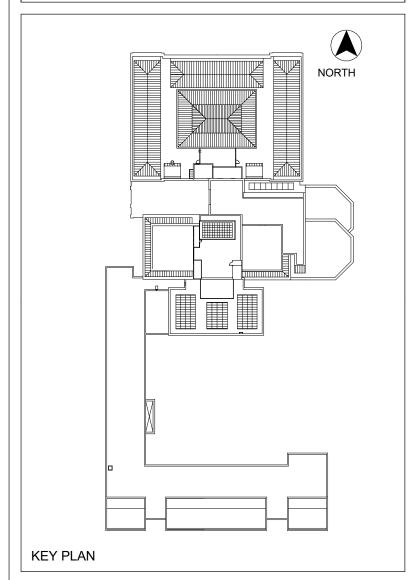
WORCESTER ART MUSEUM WORCESTER, MA

PHASE 1

REMOVAL DETAILS

Checked 7/22/2022

R1-300

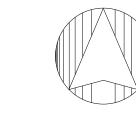


PROJECT NORTH



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KEY PLAN

REINSTALL (E) SECURITY CAMERA, CONDUIT, AND WIRING. PROVIDE REPLACEMENT GALVANIZED STEEL ATTACHMENT

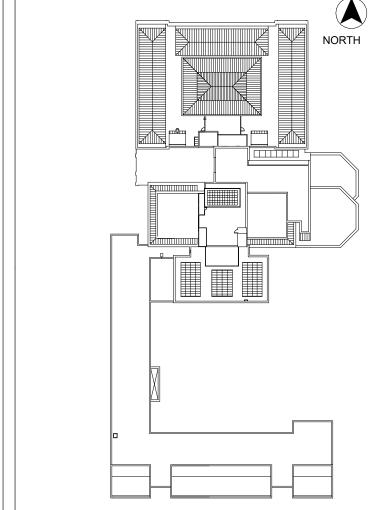SOUND (E) CONCRETE DECK AND REPAIR DELAMINATED OR SPALLED CONCRETE SURFACE; INCLUDE 10% OF AREA IN BID. 10/28/21 100% DESIGN DEVELOPMENT

PROVIDE ROOF DRAINS AND RELATED ACCESSORIES AT LOCATIONS SHOWN. AT (N) DRAIN LOCATIONS, CORE (E) CONCRETE DECK. COORDINATE WITH PLUMBING DRAWINGS FOR PIPING AND PIPE INSULATION SCOPE OF WORK. INFILL (E) DRAIN LOCATIONS.

LEGEND

TIN/ZINC-COATED COPPER CORNICE FLASHING

CONCRETE CURB WITH COPPER FLASHING

(D) BUILT-IN GUTTER DRAIN; SEE 3/BT1-320

→ SLOPE TO DRAIN; MIN. 1/4" PER FT.

● PIPE PENETRATION; SEE 9/BT1-300

DRAWINGS

ADDITIONAL 6 PIPE PENETRATIONS.

SECONDARY ROOF DRAIN; CORE (E) CONCRETE DECK AND

CONNECT TO DRAIN LEADER. SEE PLUMBING DRAWINGS.

ROOF DRAIN; REPLACE DRAIN BODY AND STRAINER AND CONNECT TO (E) DRAIN LEADER. SEE 3/ BT1-300, SIM.

PROVIDE INFILL ROOF DECKING; SEE STRUCTURAL

OUTLINE OF REPLACEMENT MECHANICAL DUCTWORK AND

L__ EQUIPMENT; COORDINATE WITH MECHANICAL DRAWINGS

1930 ROOF SCOPE OF WORK:

1. PROVIDE TWO-PLY MODIFIED BITUMEN ROOF SYSTEM, INCLUDING

PERIMETERS, CURBS, AND TRANSITIONS. PROVIDE PMMA FLUID-

APPLIED FLASHING AT PENETRATIONS. FOR PRICING, INCLUDE

VAPOR RETARDER, MECHANICALLY FASTENED TAPERED INSULATION, AND COVERBOARD. PROVIDE CRICKETS FORMED WITH TAPERED INSULATION. PROVIDE METAL FLASHING AT

EXPANSION JOINT; SEE DETAIL 6/G-300

IN GUTTER AND COPING

TWO-PLY MODIFIED BITUMEN ROOF SYSTEM; SEE 1/BT1-300

REINFORCED FLUID-APPLIED WATERPROOFING AT BUILT-

REINSTALL OR PROVIDE METAL EXHAUST VENTS AT CURBS AT LOCATIONS SHOWN. COORDINATE WITH MECHANICAL DRAWINGS

PROVIDE INFILL BLOCKING AND PLYWOOD AT BUILT-IN GUTTERS AND ADJACENT CORNICE; SLOPE GUTTERS TO DRAINS MIN. 1/4 IN. PER FT. PROVIDE REINFORCED FLUID-APPLIED WATERPROOFING AT GUTTER AND CORNICE. PROVIDE SHEET METAL CLOSURE, COPPER COUNTERFLASHING, AND TIN/ZINC-COATED COPPER DRIP

PROVIDE CORNICE DRAINS AT (E) BUILT-IN GUTTER DRAIN LOCATIONS.

PROVIDE TIN/ZINC-COATED COPPER COPING FLASHING AND COPPER STANDING SEAM PARAPET RISING WALL FLASHING.

PROVIDE CONCRETE CURB AND COPPER FLASHING AT LOCATIONS SHOWN ON THE DRAWING.

PROVIDE INTERIOR WALLS AT PIPE CHASE AND REPLACEMENT INTERIOR FINISHES AT (E) WALLS.

NOTES:
1. PROTECT ALL SURROUNDING FINISHES AND STRUCTURE TO

2. DIMENSIONS, MEMBER SIZES, EXISTING FRAMING CONFIGURATIONS, RELATIVE ELEVATIONS, SCALE, ETC. ARE SHOWN FOR REFERENCE ONLY. CONTRACTOR TO VERIFY ALL

DIMENSIONS IN FIELD PRIOR TO BIDDING. HAZARDOUS MATERIALS: HAZARDOUS MATERIALS FOUND IN PROJECT AREAS. COORDINATE WITH ABATEMENT DRAWINGS AND REQUIREMENTS OF OWNER'S HAZARDOUS MATERIALS CONSULTANT.

5 | 7/22/22 | PHASE 1 AND 2 - PERMIT SET 4 03/31/22 PHASE 3 - 90% CDs 3 | 02/11/22 | PHASE 1 AND 2 BID SET 2 | 12/16/21 | 50% CONSTRUCTION DOCUMENTS

1930s Building Roof & Fuller Lab Envelope **Improvements**

Description

WORCESTER ART MUSEUM WORCESTER, MA

PHASE 1

1930s ROOF PLAN

Drawing Title

Project No.	Checked		Date
210608.00	CCW		7/22/2022
Drawn	Approved		Scale
KEM/BBS/MAW	JSD		As indicated
		Drawing N	No.

BT1-100

(E) COVERED ŠKYLIGHT TO REMAIN (E) SKYLIGHT TO REMAIN (NOT IN SCOPE) INFILL ROOF DECK EF-30 EQUIPMENT CURBS; CRICKET UP-SEE MECHANICAL DRAWINGS SLOPE OF CURB; TYP. (E) LADDER TO REMAIN 1930s ROOF -(E) MECHANICAL ROOM INTERIOR (ELEV 44'-9") (NOT IN SCOPE) DOOR TO REMAIN DOOR TO REMAIN BT1-200 5 BT1-200 OVERHANG OF (E) FULLER LAB **ROOF ABOVE** - FULLER ROOF; SEE PHASE 2 PROVIDE INTERIOR 1930s ROOF CORNICE PARTITION WALL AT NEW CHASE

BT1-321

(E) COVERED SKYLIGHT

BT1-320

TYP. BT1-300

1930s ROOF (ELEV 44'-9")

INFILL (E) DRAIN LOCATION

(E) MECHANICAL ROOM INTERIOR

(NOT IN SCOPE)

5 BT1-300

(E) COVERED

ŠKYLIGHT TO

REMAIN

INFILL ROOF DECK

BT1-300

∖BT1-320*∫*

2

BT1-320

(E) CORNICE BELOW; TYP.

BT1-320

(E) METAL PANEL CLADDING

SEE 2/BT1-203

SYSTEM SHOWN SCHEMATICALLY;

(E) WINDOW; SEE PHASE 2 DRAWINGS

Phase 1, Complete per Decision 22AUG2022

NEW ROOF DRAIN. CORE (E) CONCRETE

DECK AND CONNECT DRAIN LEADER TO

1930s ROOF PLAN

ADJACENT (E) DRAIN PIPING AT

MEZZANINE LEVEL

FULLER LAB EXTERIOR WALL PART PLAN

FULLER LAB

(ELEV 36'-1")

3'-0"

BT1-330

LEGEND

TWO-PLY MODIFIED BITUMEN ROOF SYSTEM; SEE 1/BT1-300

EPDM ROOF SYSTEM; SEE 1/BT1-310

TIN/ZINC-COATED COPPER COPING OR CURB FLASHING

ALUMINUM HUNG GUTTER 1/BT1-320

•DL DOWNLEADER

→ SLOPE TO DRAIN; MIN. 1/4" PER FT.

● PENETRATION; SEE 2/BT1-310

MECHANICAL ROOM ROOF SCOPE OF WORK:

1. PROVIDE TWO-PLY MODIFIED BITUMEN ROOF SYSTEM, INCLUDING VAPOR RETARDER, MECHANICALLY FASTENED TAPERED INSULATION, AND COVERBOARD. PROVIDE CRICKETS FORMED WITH TAPERED INSULATION. PROVIDE METAL FLASHING AT PERIMETERS, CURBS, AND TRANSITIONS.

2. PROVIDE EPDM ROOF SYSTEM, INCLUDING VAPOR RETARDER, MECHANICALLY FASTENED TAPERED INSULATION, AND COVERBOARD. PROVIDE CRICKETS FORMED WITH TAPERED INSULATION. PROVIDE METAL FLASHING AT PERIMETERS, CURBS, AND TRANSITIONS.

3. PROVIDE GUTTERS AT LOCATIONS SHOWN ON DRAWING.


4. SOUND (E) CONCRETE DECK AND REPAIR DELAMINATED OR SPALLED CONCRETE SURFACE; INCLUDE 5% OF AREA IN BID.

NOTES:
1. PROTECT ALL SURROUNDING FINISHES AND STRUCTURE TO

DIMENSIONS, MEMBER SIZES, EXISTING FRAMING
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 HAZARDOUS MATERIALS: HAZARDOUS MATERIALS FOUND IN
PROJECT AREAS. COORDINATE WITH ABATEMENT DRAWINGS AND
REQUIREMENTS OF OWNER'S HAZARDOUS MATERIALS
CONSULTANT.

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KEY PLAN

5 7/22/22 PHASE 1 AND 2 - PERMIT SET
4 03/31/22 PHASE 3 - 90% CDs
3 02/11/22 PHASE 1 AND 2 BID SET
2 12/16/21 50% CONSTRUCTION DOCUMENTS
1 10/28/21 100% DESIGN DEVELOPMENT
No. Date Description By

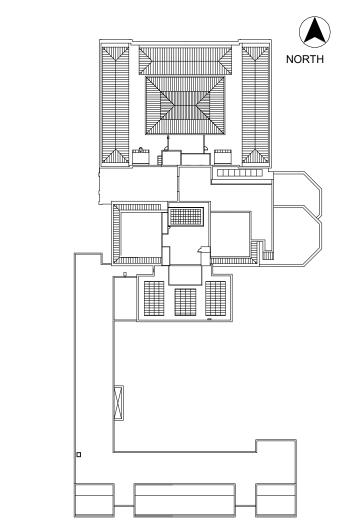1930s Building Roof & Fuller Lab Envelope Improvements

WORCESTER ART MUSEUM WORCESTER, MA

Project


PHASE 1
FULLER ROOF AND
MECHANICAL ROOM
ROOFS

Drawing Title

Project No. Checked Date 7/22/2022

Drawn Approved Scale As indicated

BT1-101

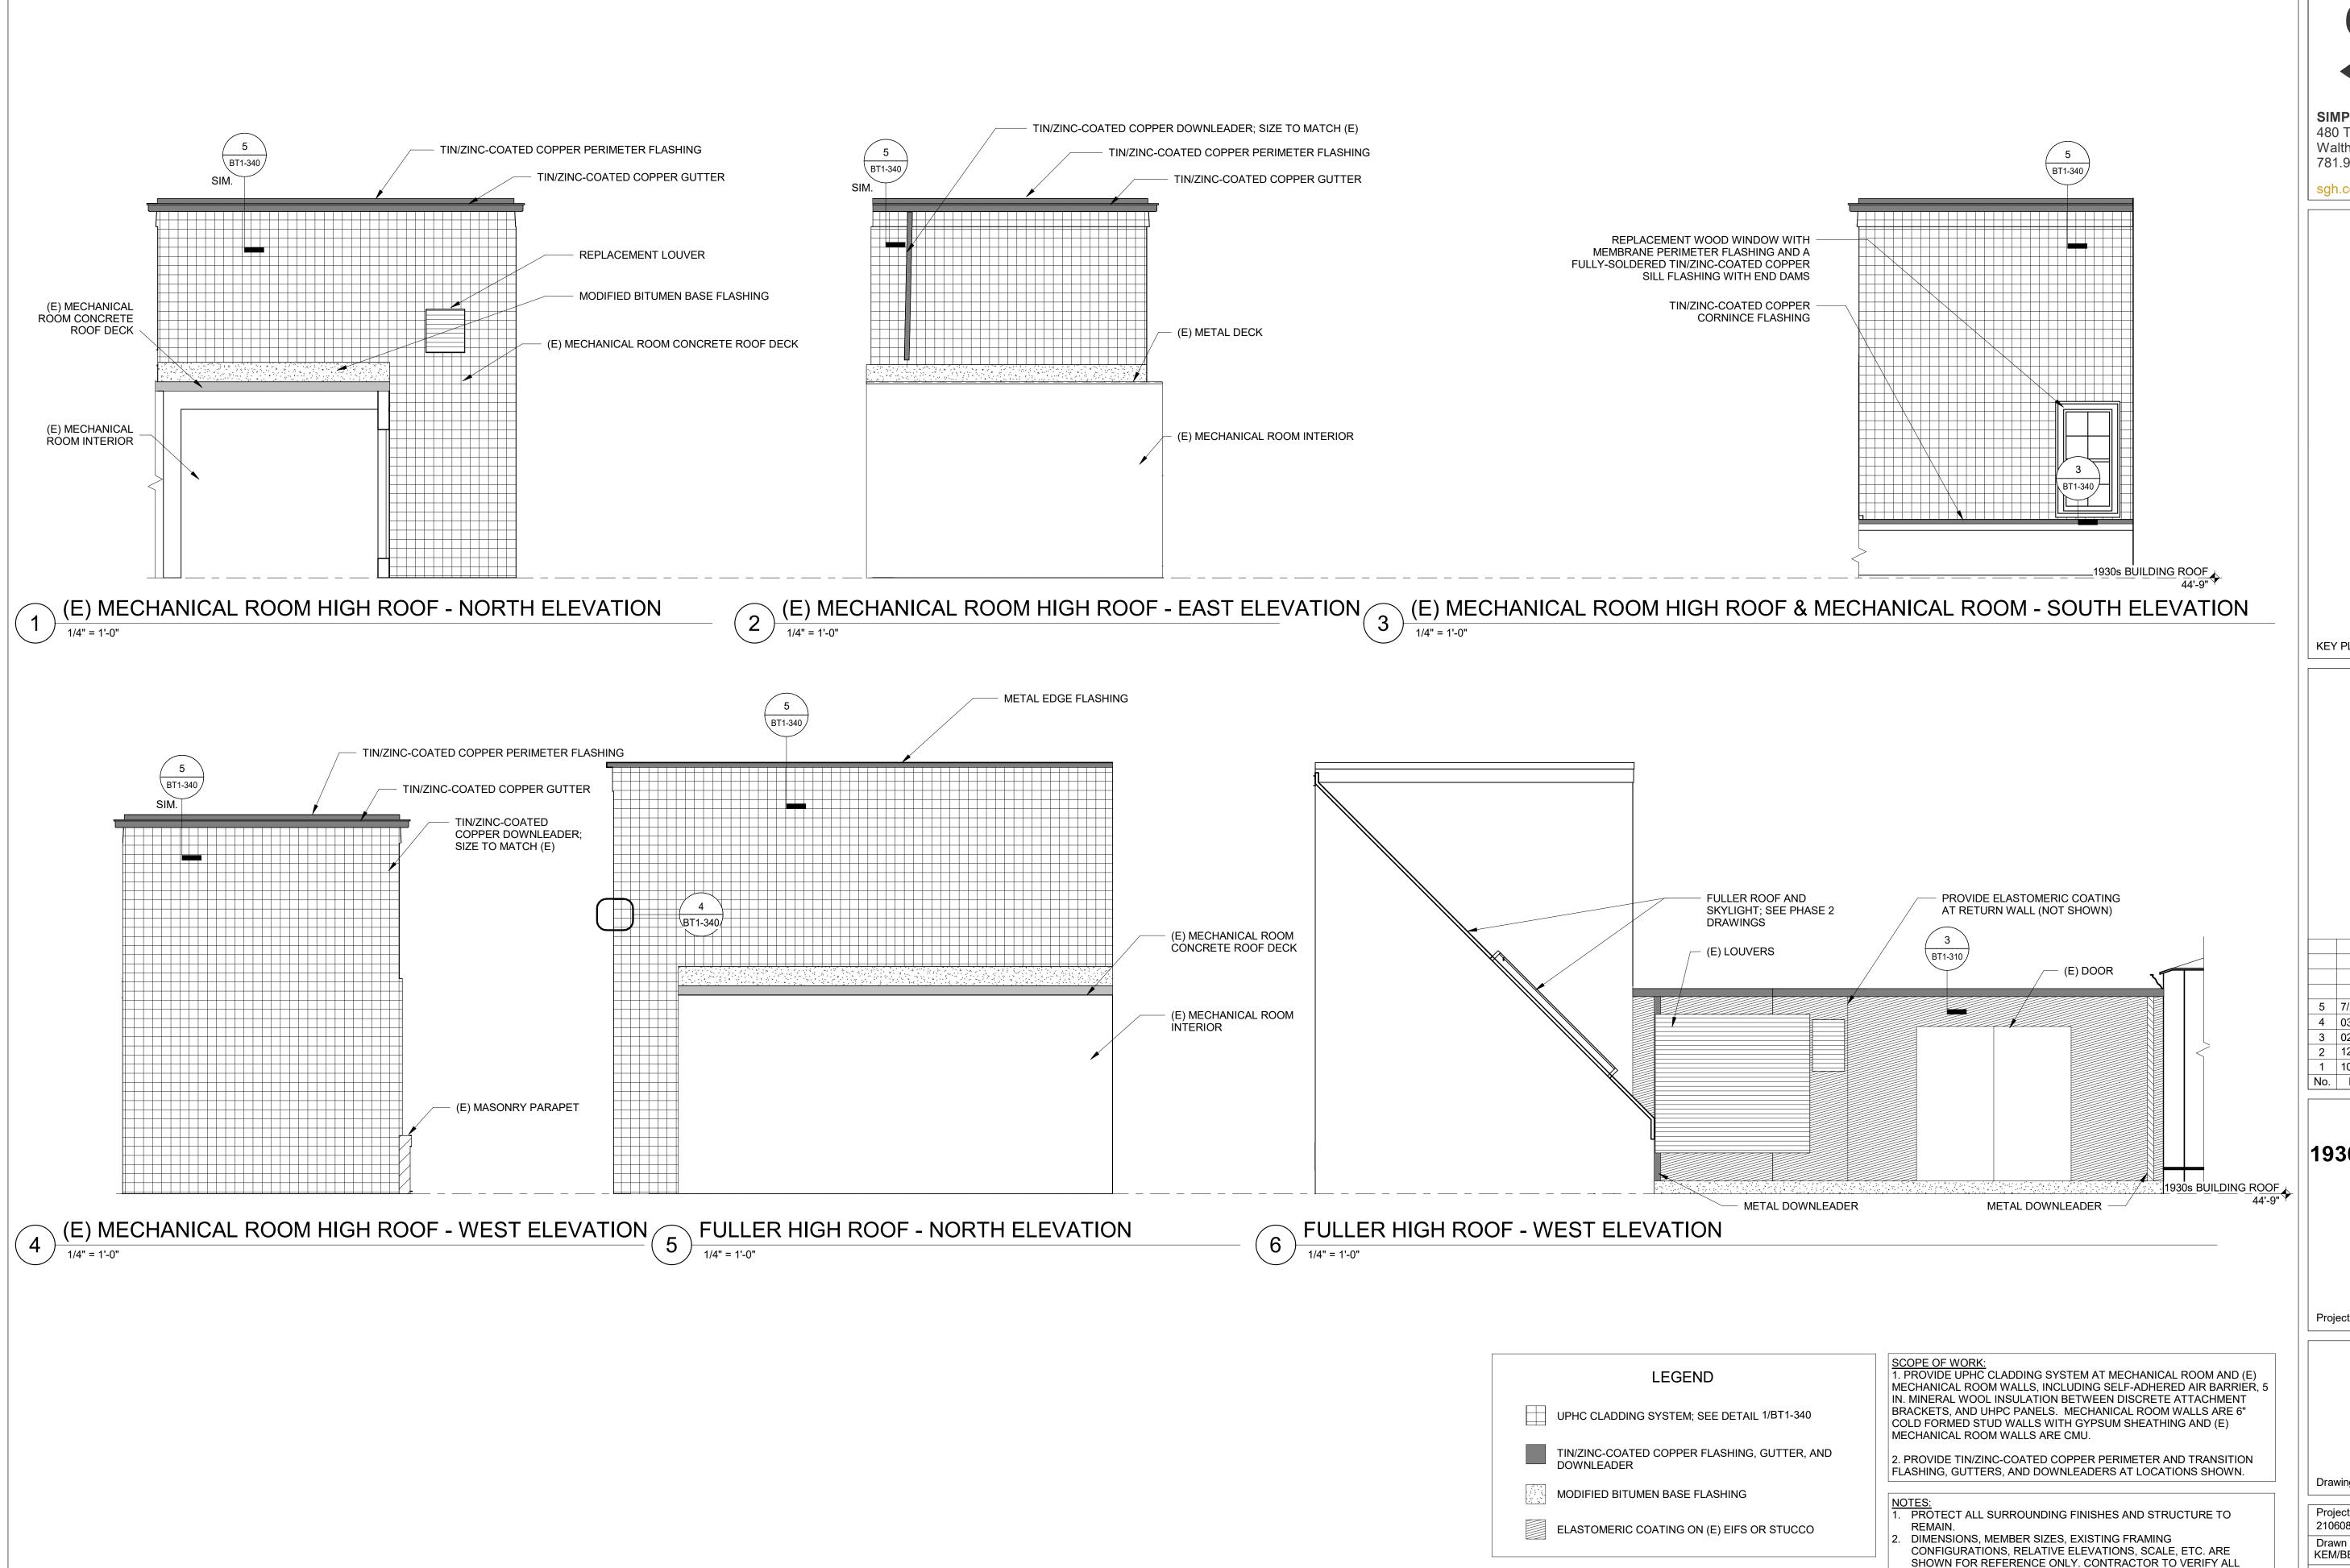

Phase 1, Complete per Decision 22AUG2022


SIMPSON GUMPERTZ & HEGER 480 Totten Pond Road Waltham, MA 02451 781.907.9000 sgh.com KEY PLAN 5 7/22/22 PHASE 1 AND 2 - PERMIT SET 4 03/31/22 PHASE 3 - 90% CDs 3 | 02/11/22 | PHASE 1 AND 2 BID SET 2 | 12/16/21 | 50% CONSTRUCTION DOCUMENTS 10/28/21 100% DESIGN DEVELOPMENT 1930s Building Roof & Fuller Lab Envelope **Improvements WORCESTER ART MUSEUM** WORCESTER, MA PHASE 1 **MECHANICAL ROOM ELEVATIONS** Drawing Title Project No Checked 210608.00 7/22/2022 Drawn Scale KEM/BBS/MAW As indicated PROJECT AREAS. COORDINATE WITH ABATEMENT DRAWINGS AND BT1-200


DIMENSIONS IN FIELD PRIOR TO BIDDING.


CONSULTANT.


HAZARDOUS MATERIALS: HAZARDOUS MATERIALS FOUND IN

REQUIREMENTS OF OWNER'S HAZARDOUS MATERIALS

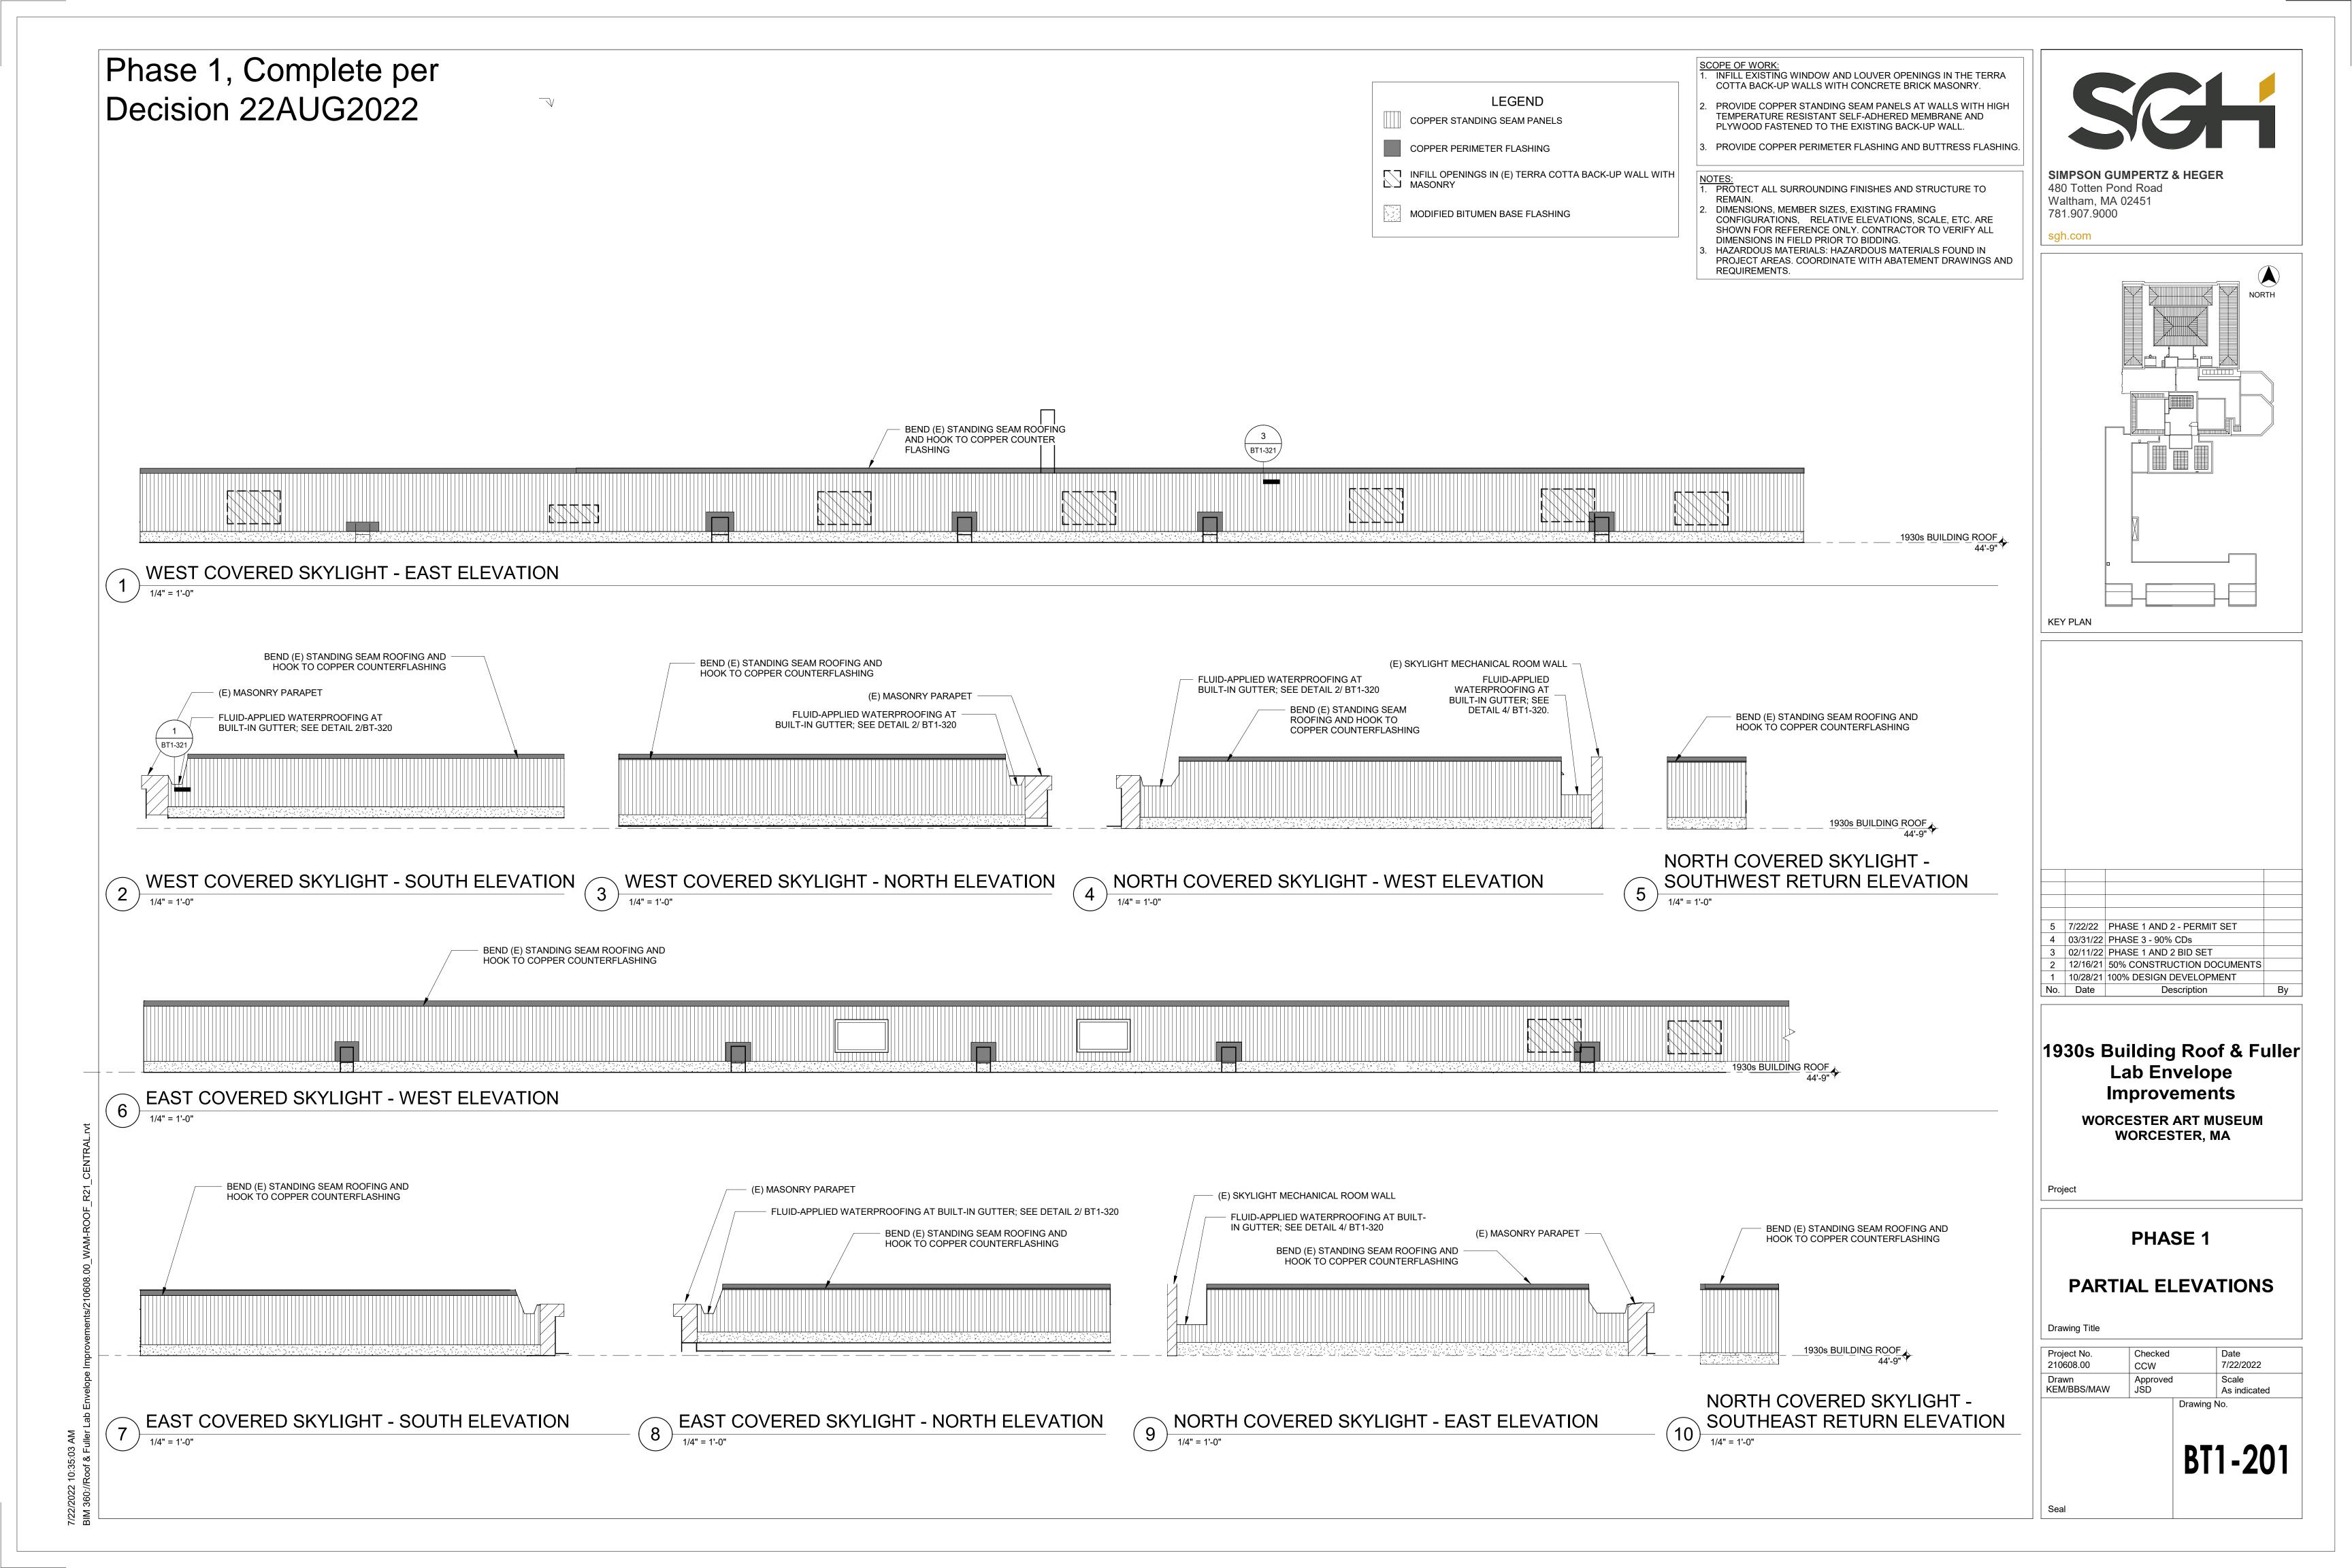


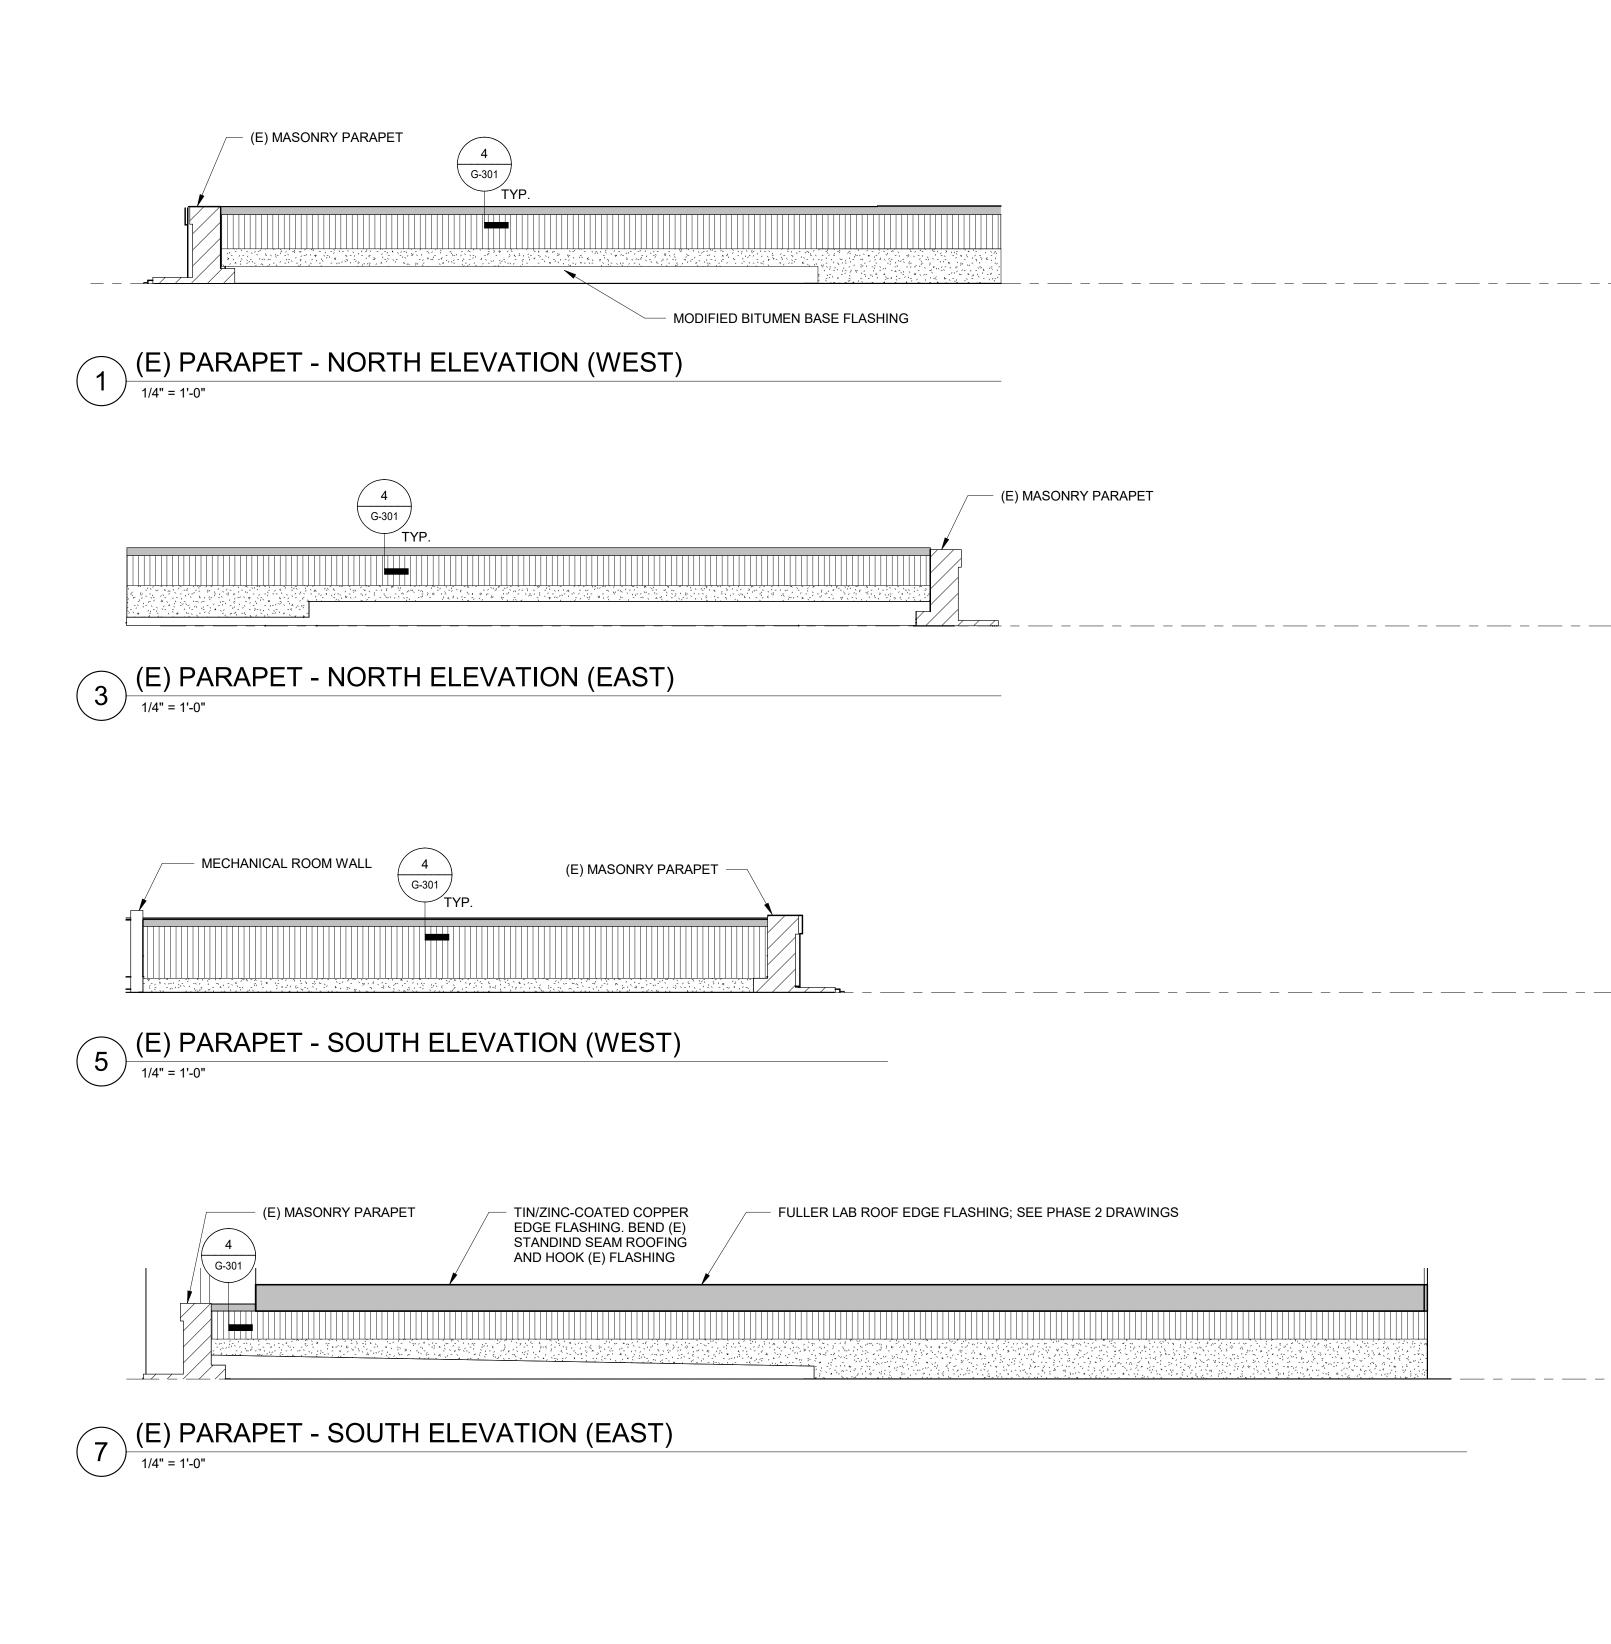

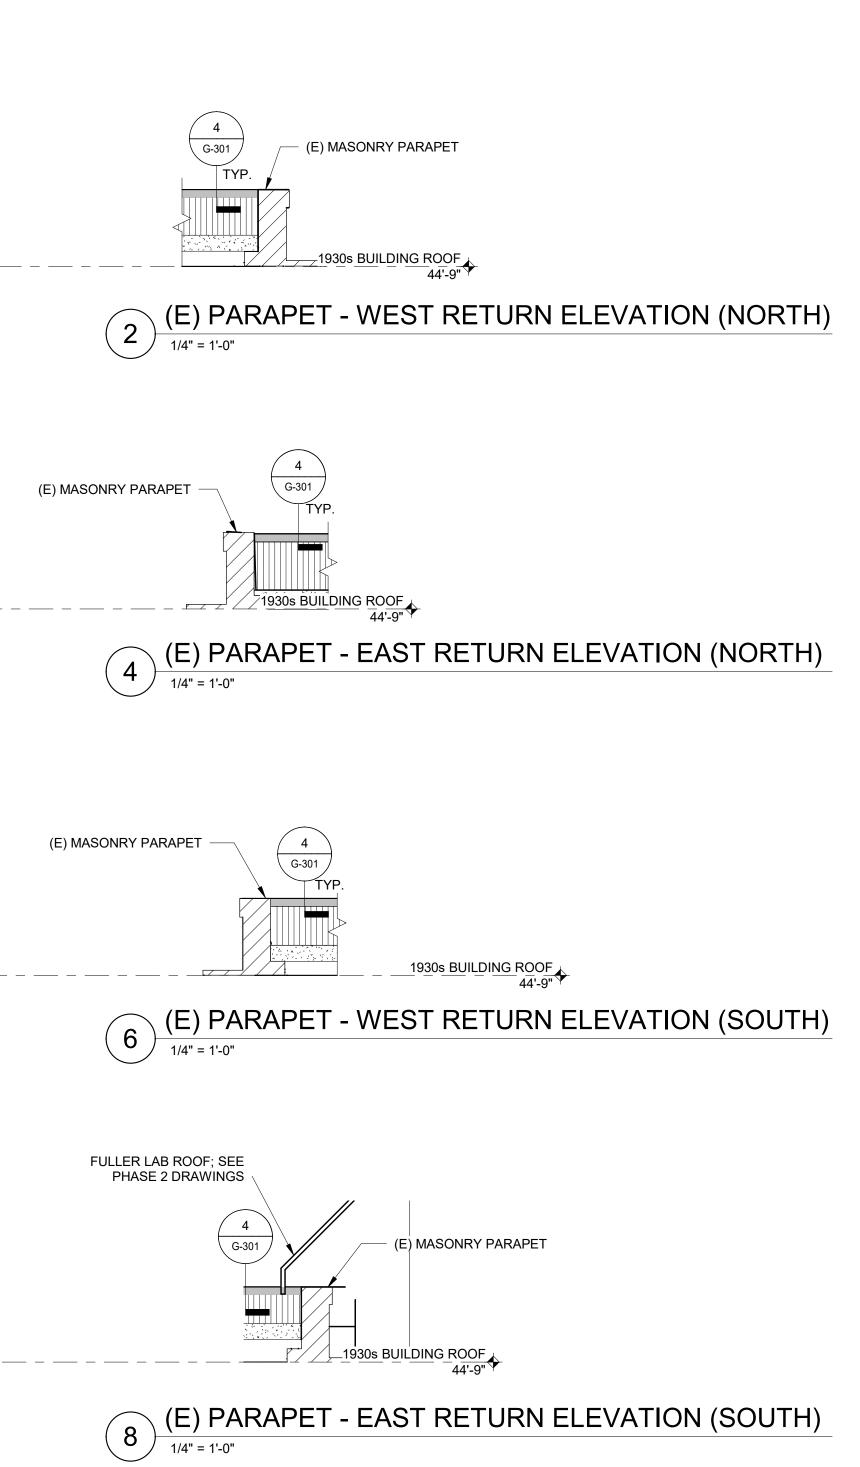

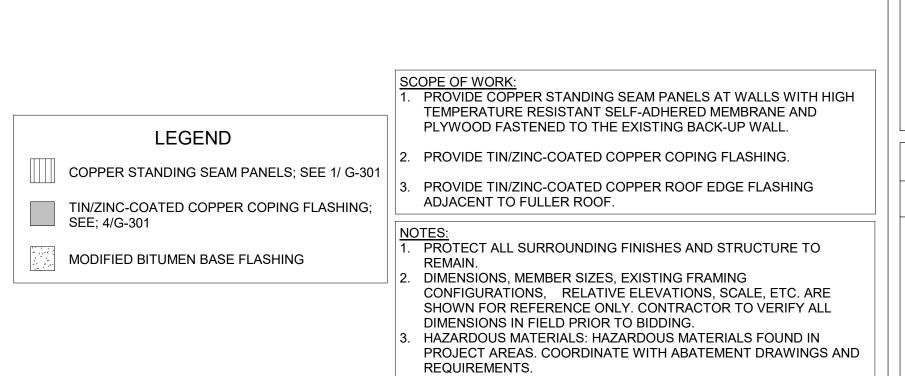



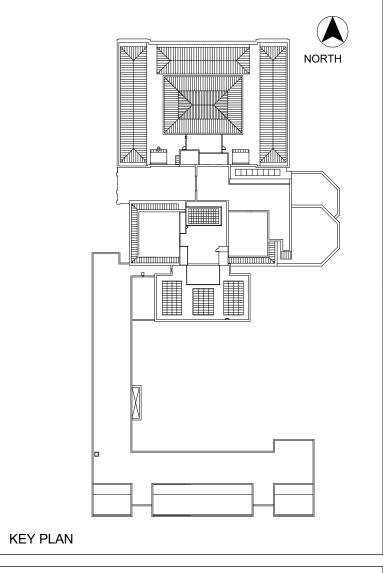

5 7/22/22 PHASE 1 AND 2 - PERMIT SET 4 03/31/22 PHASE 3 - 90% CDs 3 02/11/22 PHASE 1 AND 2 BID SET 2 12/16/21 50% CONSTRUCTION DOCUMENTS 1 10/28/21 100% DESIGN DEVELOPMENT No. Date Description By				
4 03/31/22 PHASE 3 - 90% CDs 3 02/11/22 PHASE 1 AND 2 BID SET 2 12/16/21 50% CONSTRUCTION DOCUMENTS 1 10/28/21 100% DESIGN DEVELOPMENT				
4 03/31/22 PHASE 3 - 90% CDs 3 02/11/22 PHASE 1 AND 2 BID SET 2 12/16/21 50% CONSTRUCTION DOCUMENTS 1 10/28/21 100% DESIGN DEVELOPMENT				
4 03/31/22 PHASE 3 - 90% CDs 3 02/11/22 PHASE 1 AND 2 BID SET 2 12/16/21 50% CONSTRUCTION DOCUMENTS 1 10/28/21 100% DESIGN DEVELOPMENT				
4 03/31/22 PHASE 3 - 90% CDs 3 02/11/22 PHASE 1 AND 2 BID SET 2 12/16/21 50% CONSTRUCTION DOCUMENTS 1 10/28/21 100% DESIGN DEVELOPMENT				
4 03/31/22 PHASE 3 - 90% CDs 3 02/11/22 PHASE 1 AND 2 BID SET 2 12/16/21 50% CONSTRUCTION DOCUMENTS 1 10/28/21 100% DESIGN DEVELOPMENT				
4 03/31/22 PHASE 3 - 90% CDs 3 02/11/22 PHASE 1 AND 2 BID SET 2 12/16/21 50% CONSTRUCTION DOCUMENTS 1 10/28/21 100% DESIGN DEVELOPMENT				
3 02/11/22 PHASE 1 AND 2 BID SET 2 12/16/21 50% CONSTRUCTION DOCUMENTS 1 10/28/21 100% DESIGN DEVELOPMENT	5	7/22/22	PHASE 1 AND 2 - PERMIT SET	
2 12/16/21 50% CONSTRUCTION DOCUMENTS 1 10/28/21 100% DESIGN DEVELOPMENT	4	03/31/22	PHASE 3 - 90% CDs	
1 10/28/21 100% DESIGN DEVELOPMENT	3	02/11/22	PHASE 1 AND 2 BID SET	
	2	12/16/21	50% CONSTRUCTION DOCUMENTS	
No. Date Description By	1	10/28/21	100% DESIGN DEVELOPMENT	
	No.	Date	Description	Ву

1930s Building Roof & Fuller Lab Envelope Improvements

WORCESTER ART MUSEUM WORCESTER, MA

Proje


PHASE 1

PARAPET ELEVATIONS

Drawing Title

	Project No.	Checked		Date
	210608.00	CCW		7/22/2022
	Drawn	Approved		Scale
	KEM/BBS/MAW	JSD		As indicated
			Drawing I	No.
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BT1-202



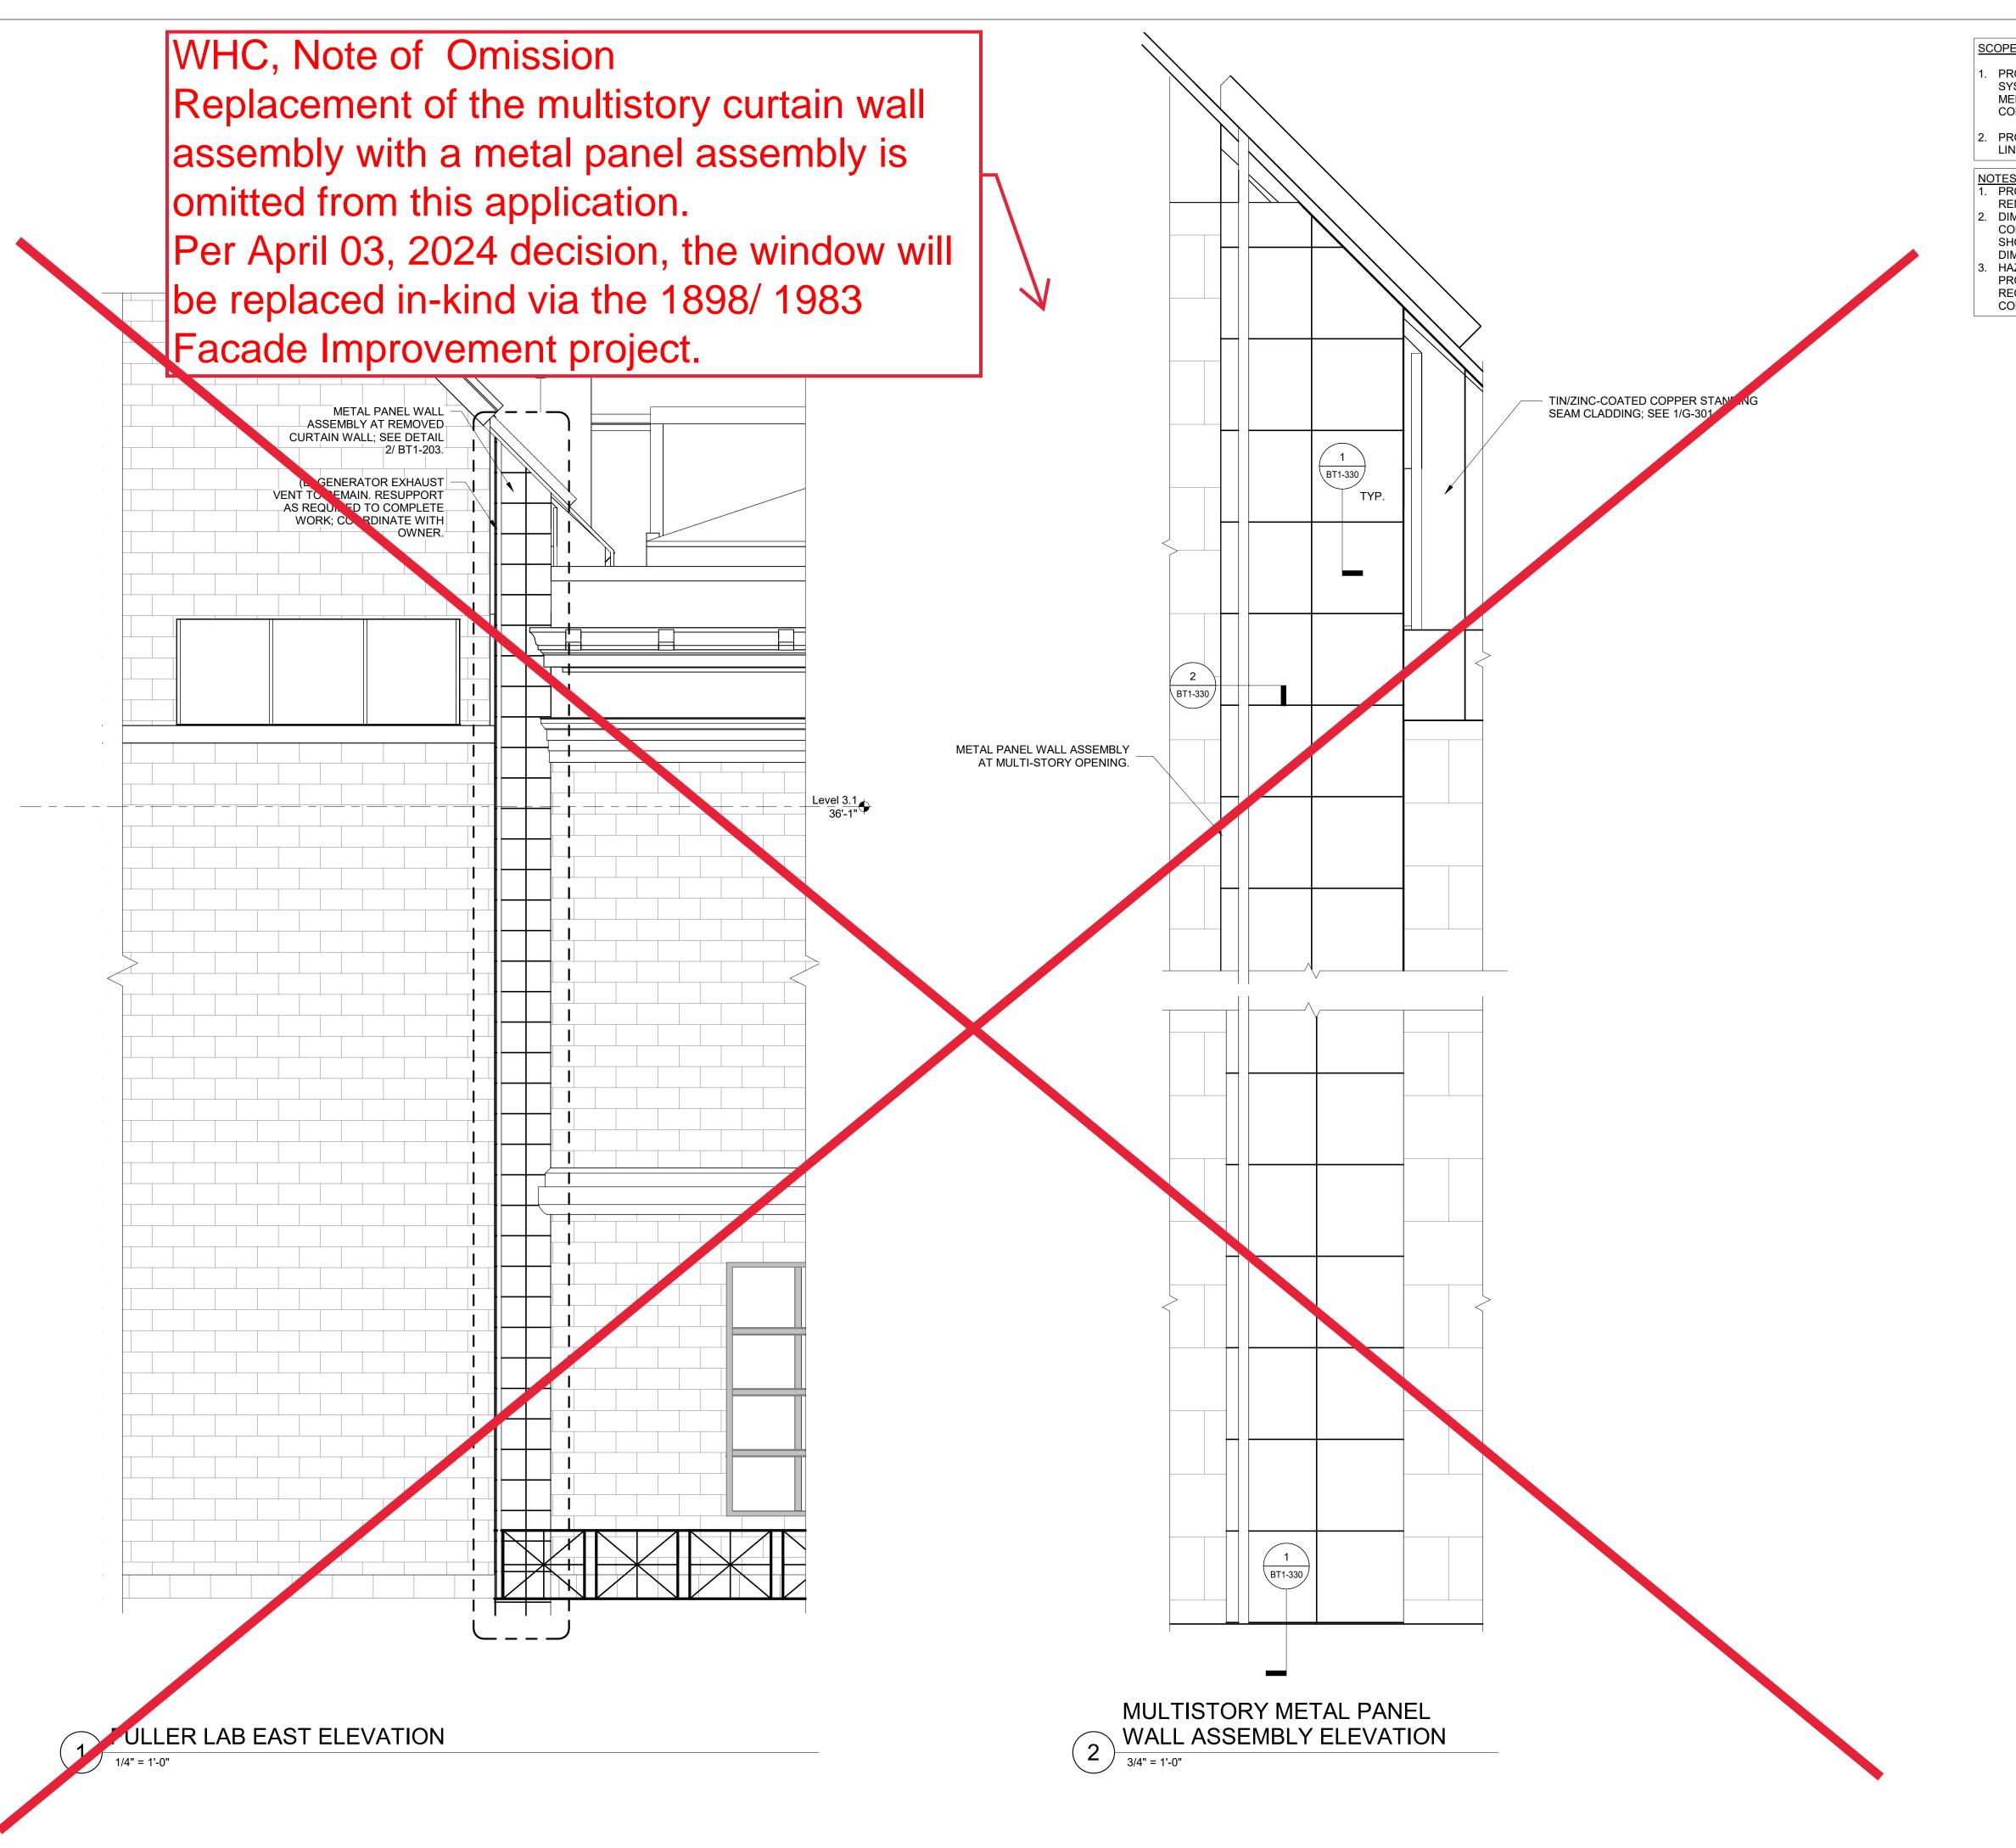


- 1. PROVIDE METAL PANELS WITH SUB-FRAMING ATTACHMENT SYSTEM, MINERAL WOOL INSULATION, SELF-ADHERING SHEET MEMBRANE AIR BARRIER MEMBRANE, EXTERIOR SHEATHING, AND COLD-FORMED METAL FRAMING AT MULTI-STORY OPENING.
- 2. PROVIDE UL-APPROVED FIRESTOPPING AND JOINT AT FLOOR LINES.
- NOTES:

 1. PROTECT ALL SURROUNDING FINISHES AND STRUCTURE TO
- 2. DIMENSIONS, MEMBER SIZES, EXISTING FRAMING CONFIGURATIONS, RELATIVE ELEVATIONS, SCALE, ETC. ARE SHOWN FOR REFERENCE ONLY. CONTRACTOR TO VERIFY ALL DIMENSIONS IN FIELD PRIOR TO BIDDING.
- HAZARDOUS MATERIALS: HAZARDOUS MATERIALS FOUND IN PROJECT AREAS. COORDINATE WITH ABATEMENT DRAWINGS AND REQUIREMENTS OF OWNER'S HAZARDOUS MATERIALS CONSULTANT



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5	7/22/22	PHASE 1 AND 2 - PERMIT SET	
4	03/31/22	PHASE 3 - 90% CDs	
3	02/11/22	PHASE 1 AND 2 BID SET	
2	12/16/21	50% CONSTRUCTION DOCUMENTS	
1	10/28/21	100% DESIGN DEVELOPMENT	
No.	Date	Description	E

1930s Building Roof & Fuller Lab Envelope Improvements

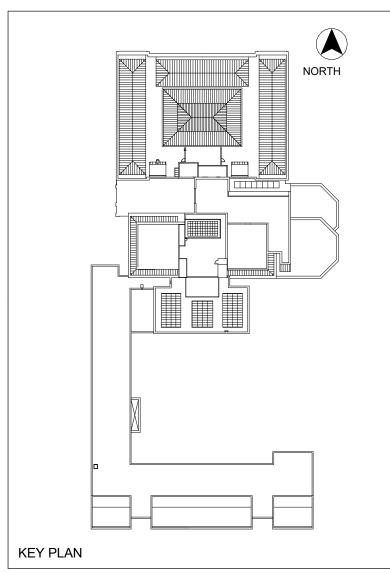WORCESTER ART MUSEUM WORCESTER, MA

Project

PHASE 1

FULLER LAB PARTIAL ELEVATIONS


Drawing Title

Project No.	Checked	Date
210608.00	CCW	7/22/2022
Drawn KEM/BBS/MAW	Approved JSD	Scale As indicated
	Drawing	Nο

BT1-203

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KEY PLAN

NORTH

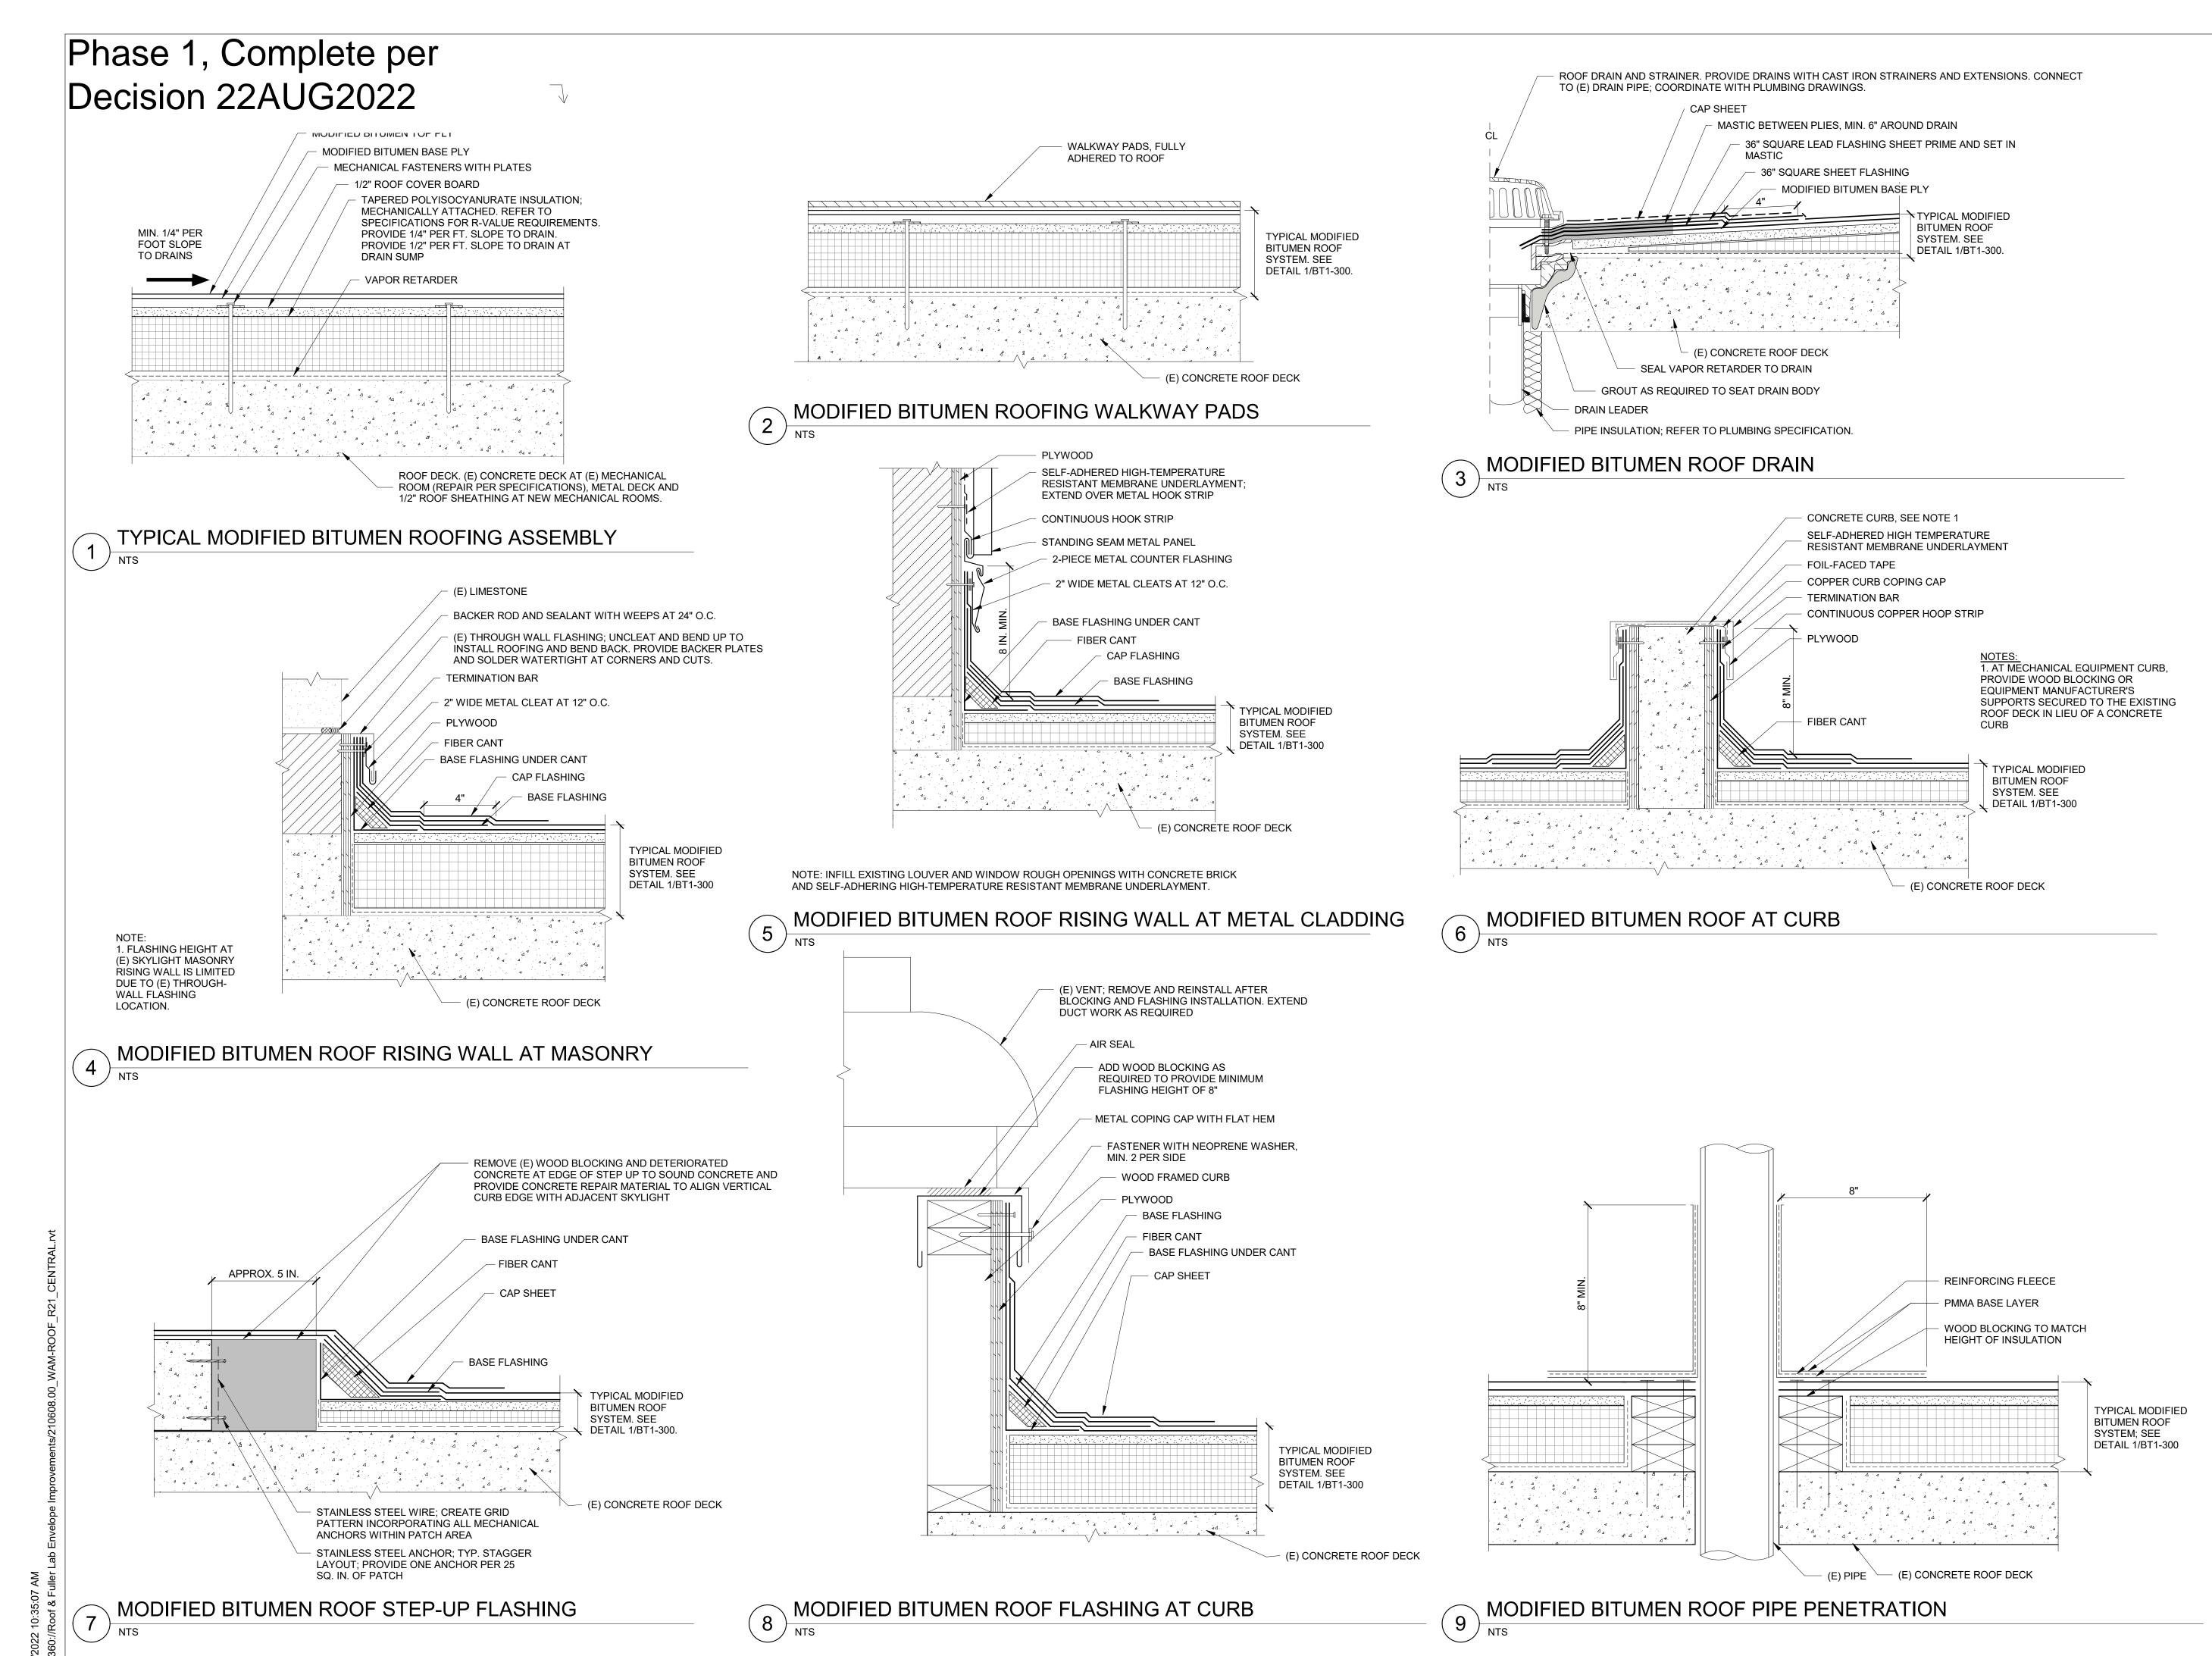5 7/22/22 PHASE 1 AND 2 - PERMIT SET
4 03/31/22 PHASE 3 - 90% CDs
3 02/11/22 PHASE 1 AND 2 BID SET
2 12/16/21 50% CONSTRUCTION DOCUMENTS
1 10/28/21 100% DESIGN DEVELOPMENT
No. Date Description By

1930s Building Roof & Fuller Lab Envelope Improvements

WORCESTER ART MUSEUM WORCESTER, MA

Project

PHASE 1


MODIFIED BITUMEN ROOF
DETAILS

Drawing Title


Project No. 210608.00 CCW 7/22/2022

Drawn Approved Scale As indicated Drawing No.

BT1-300

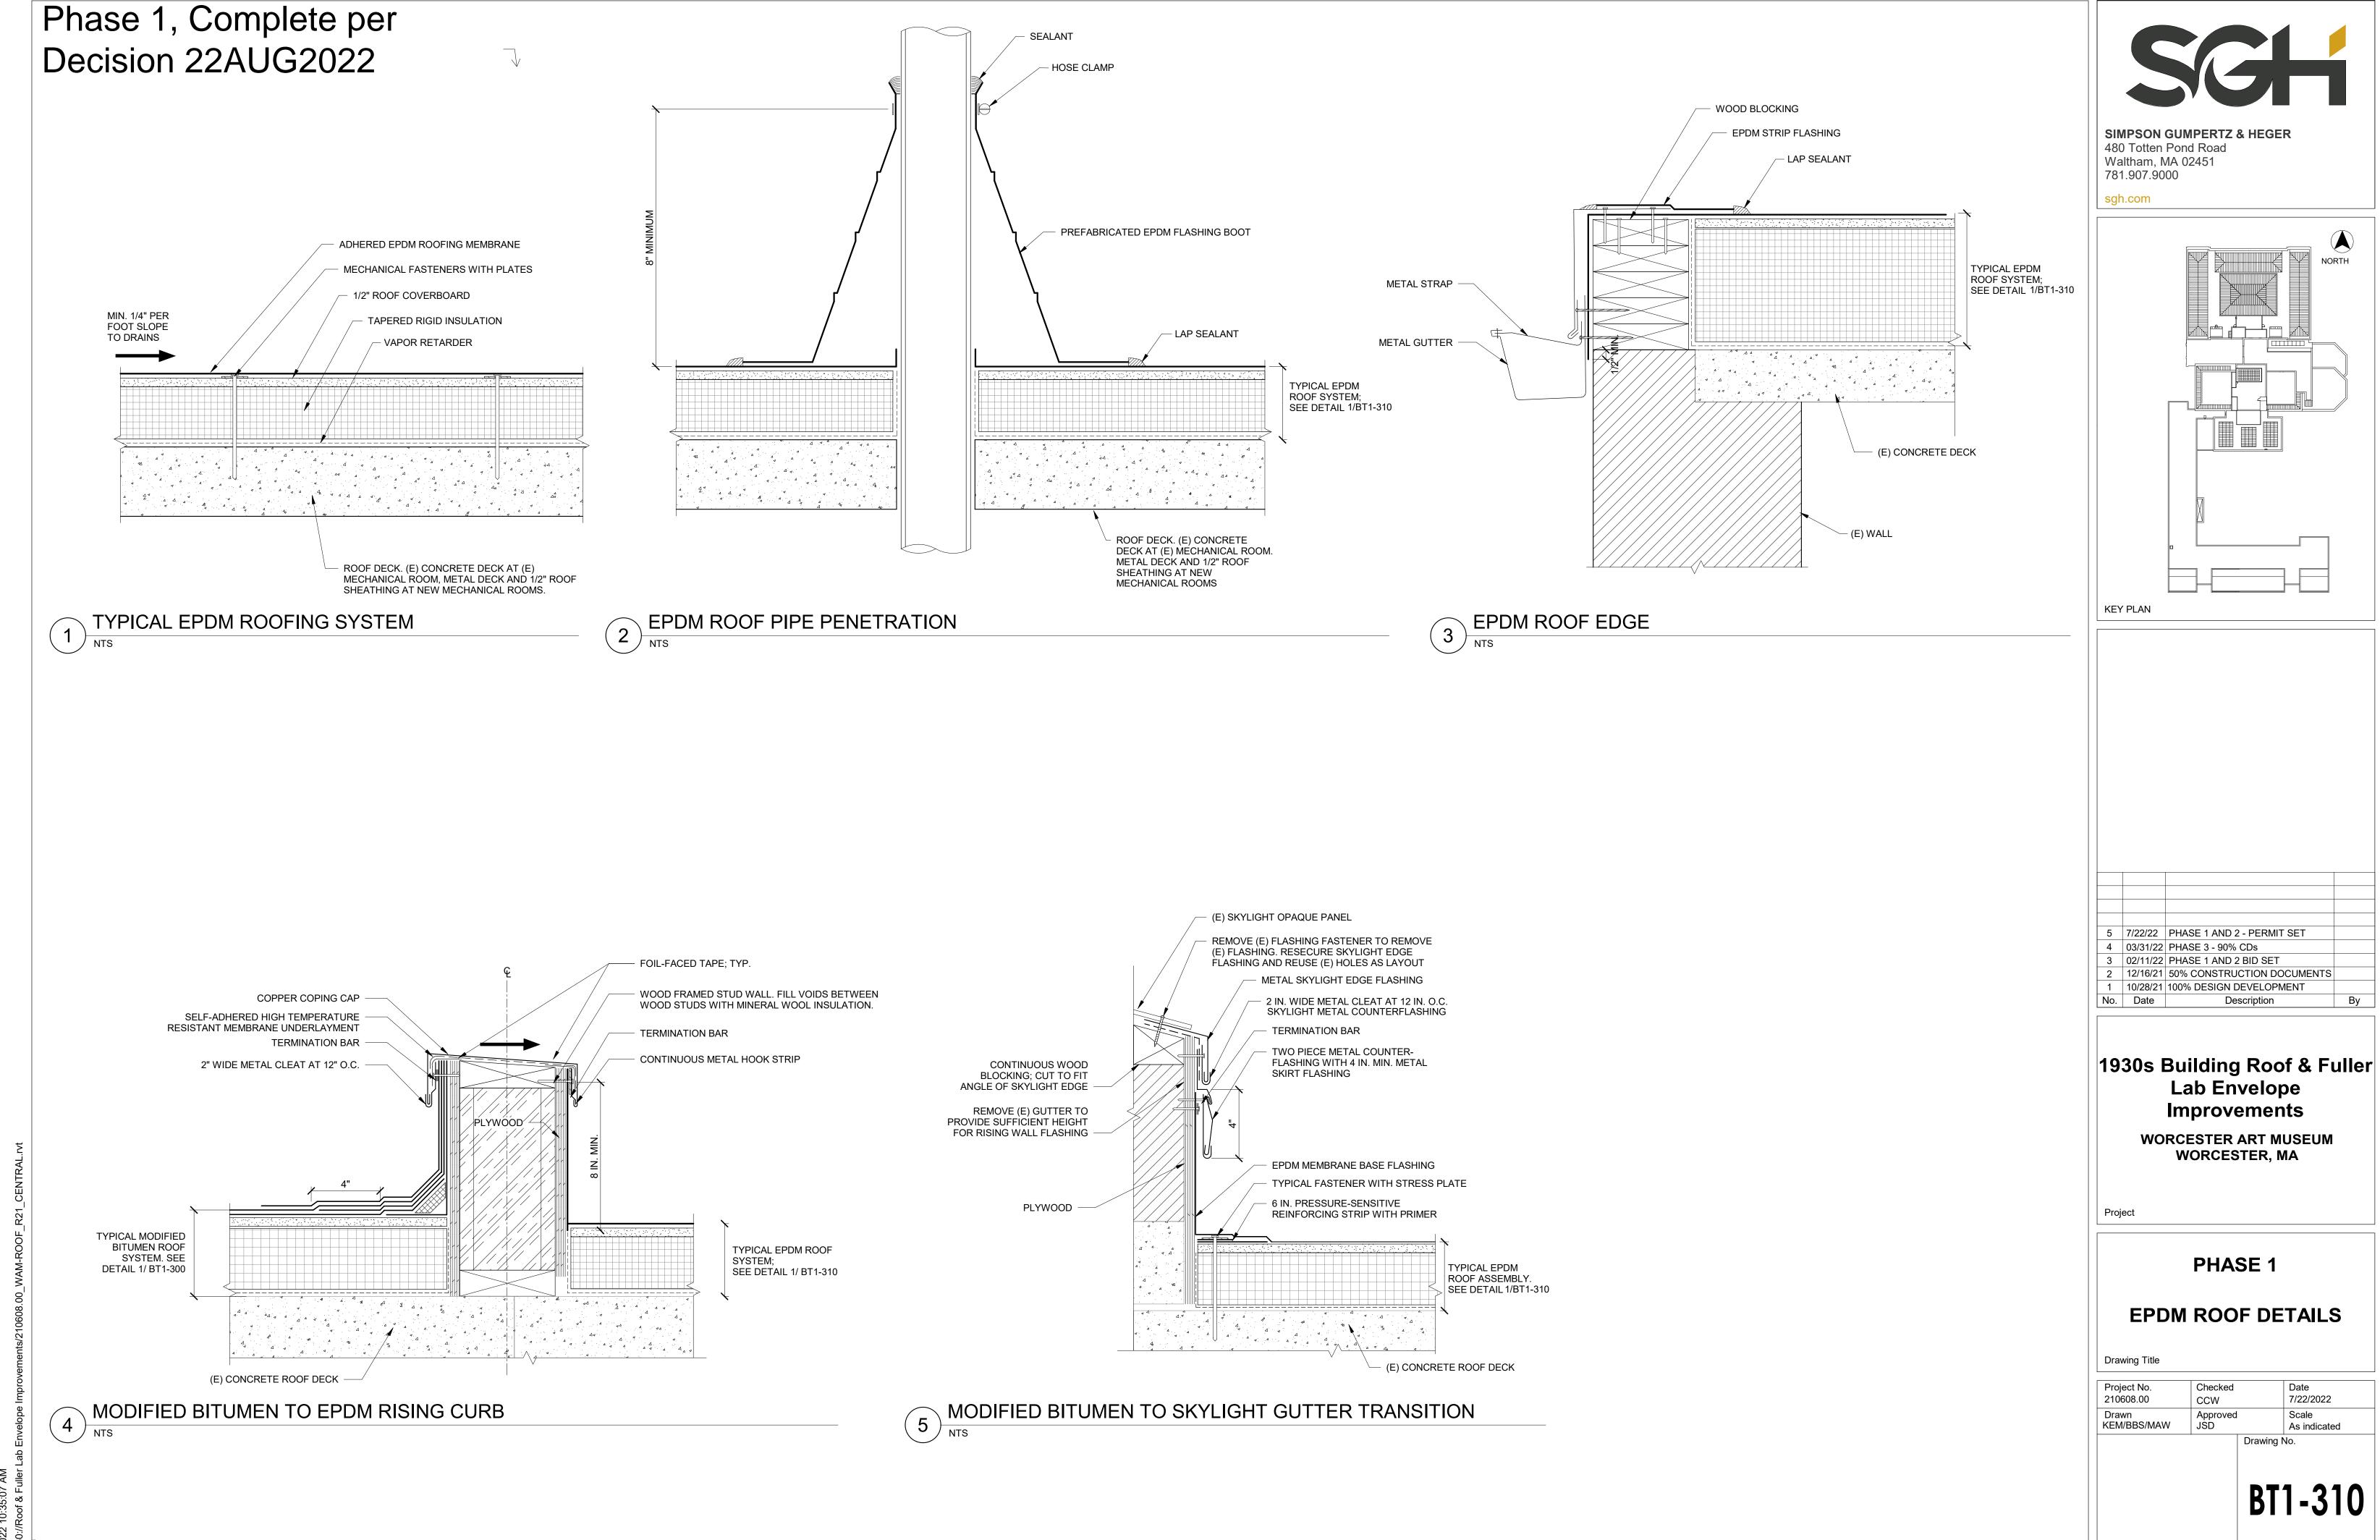


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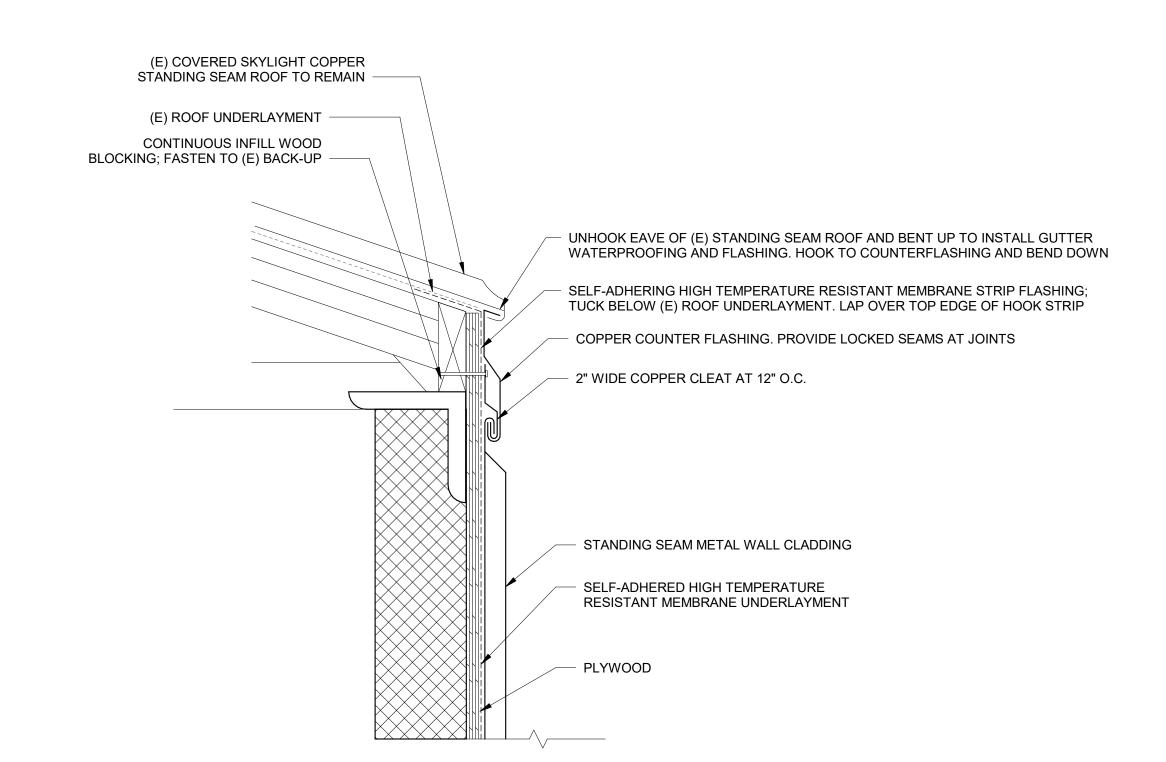

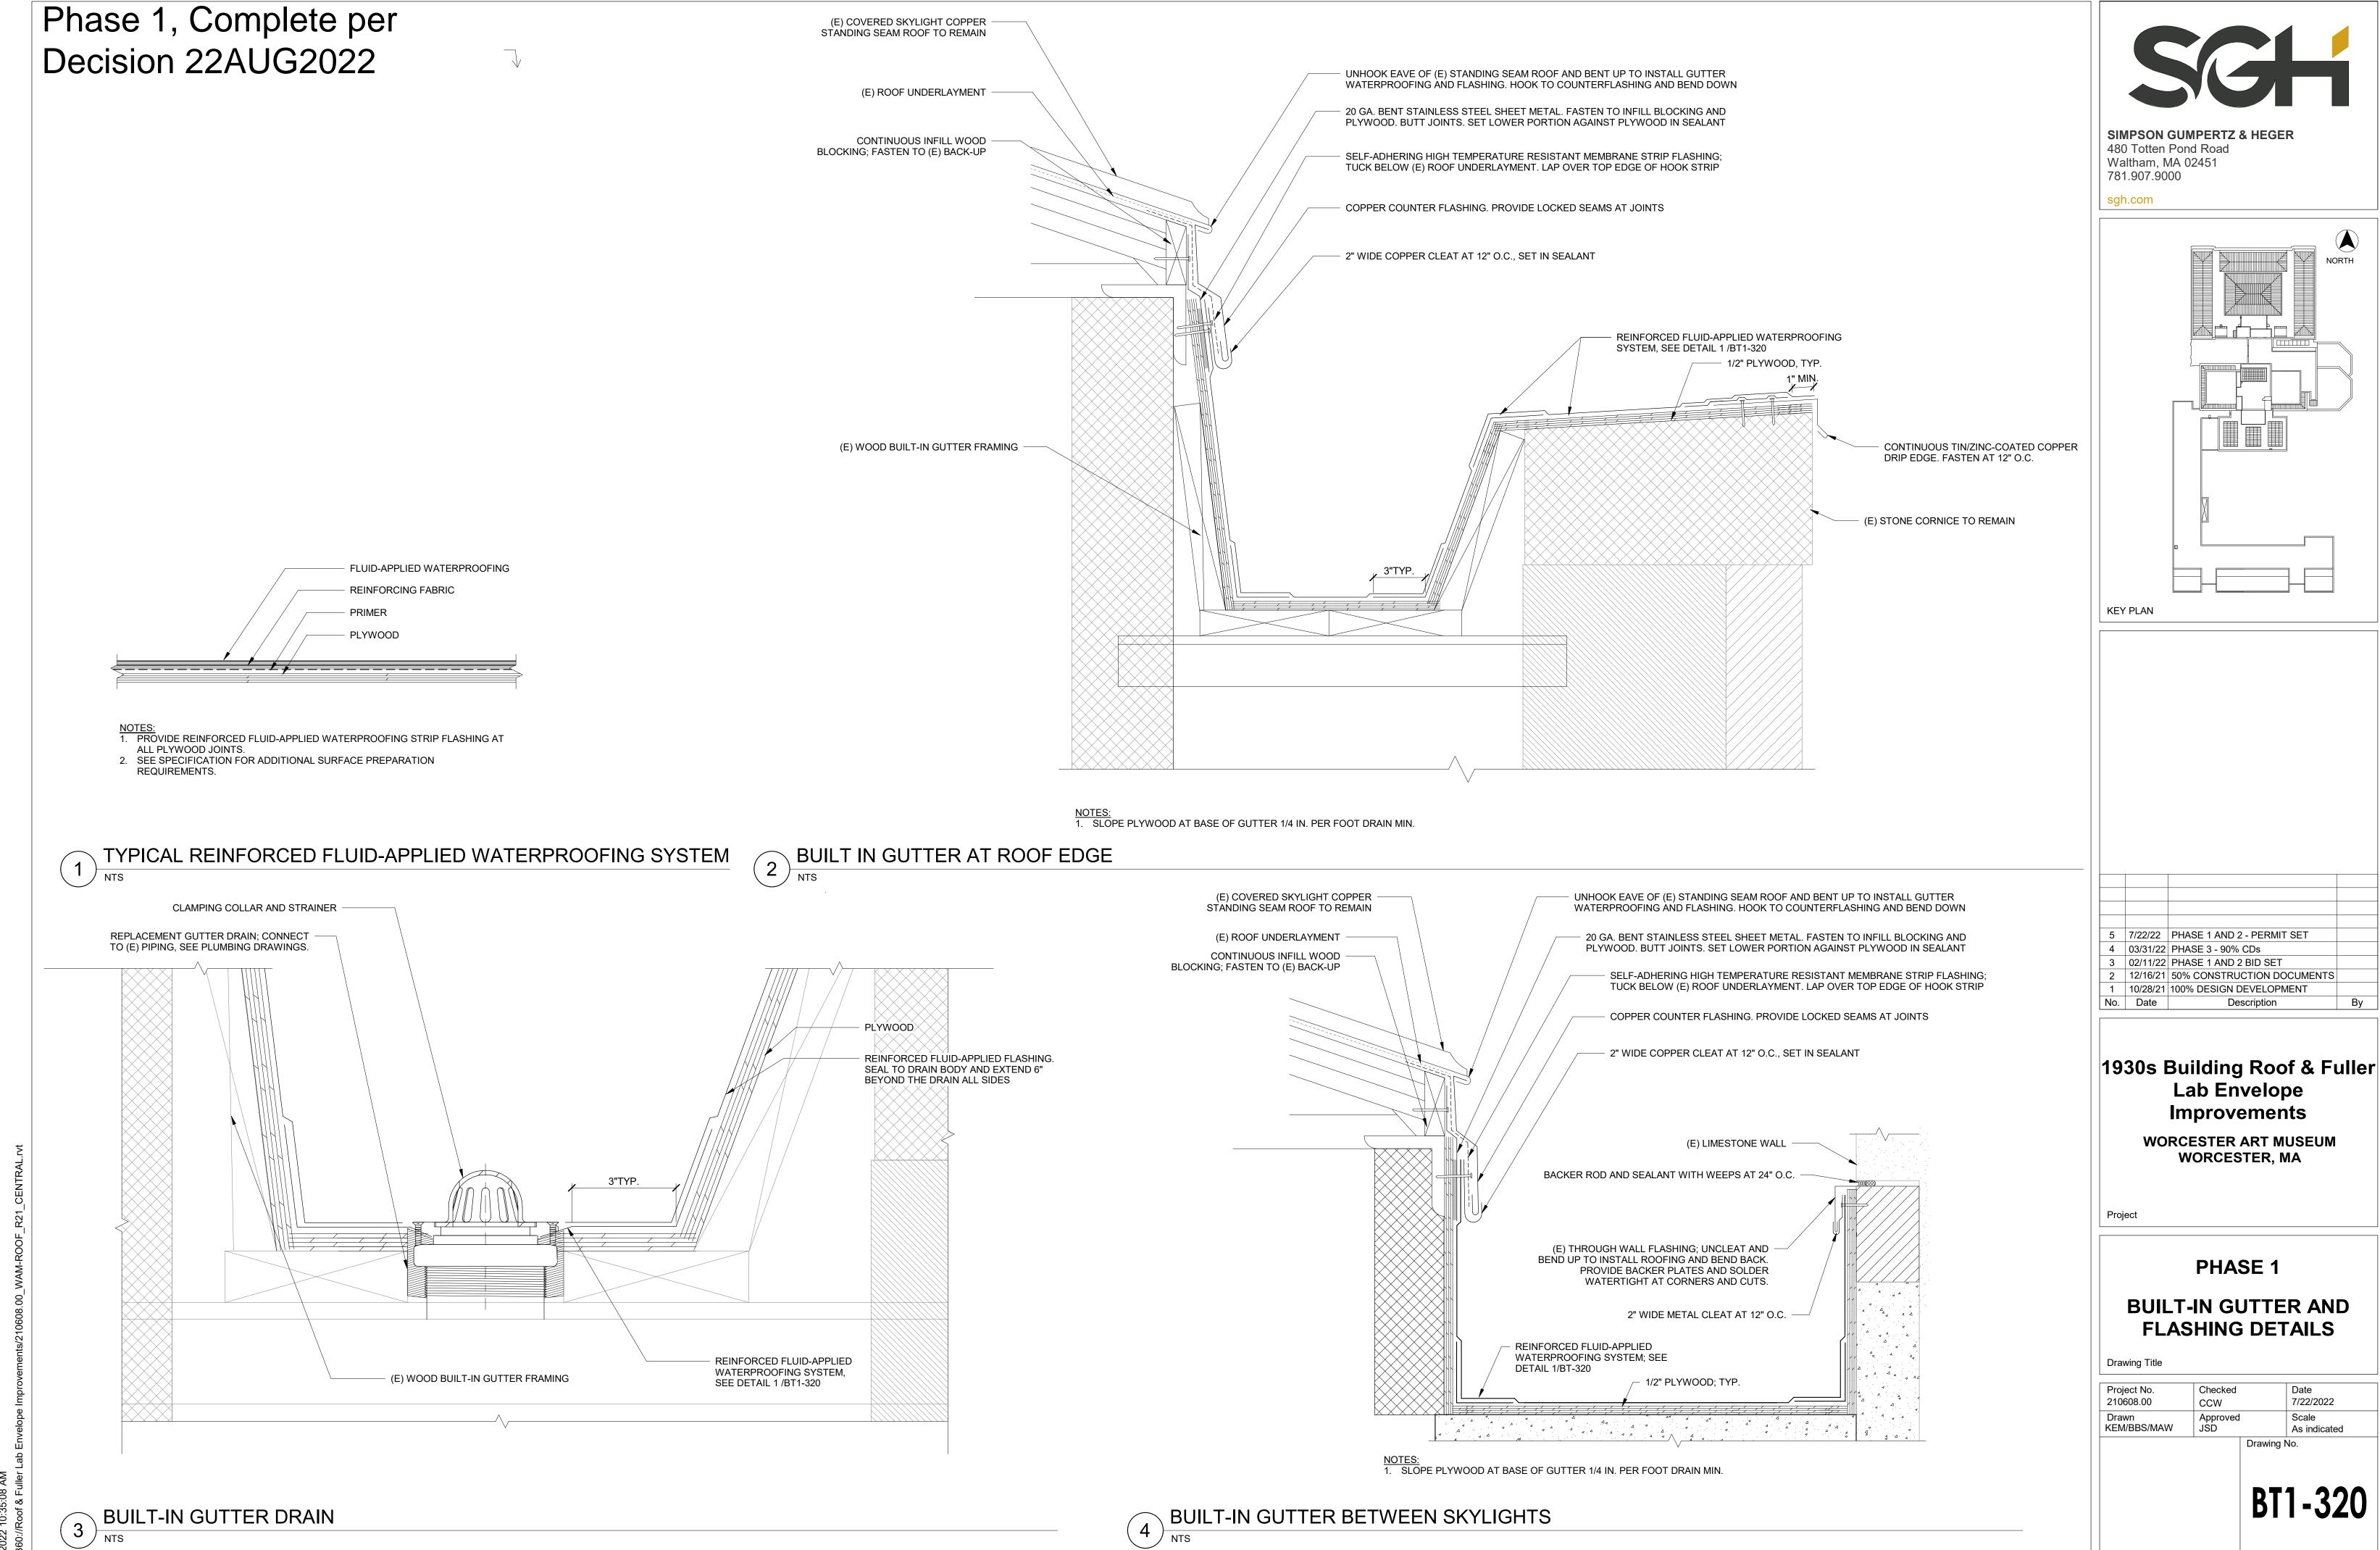
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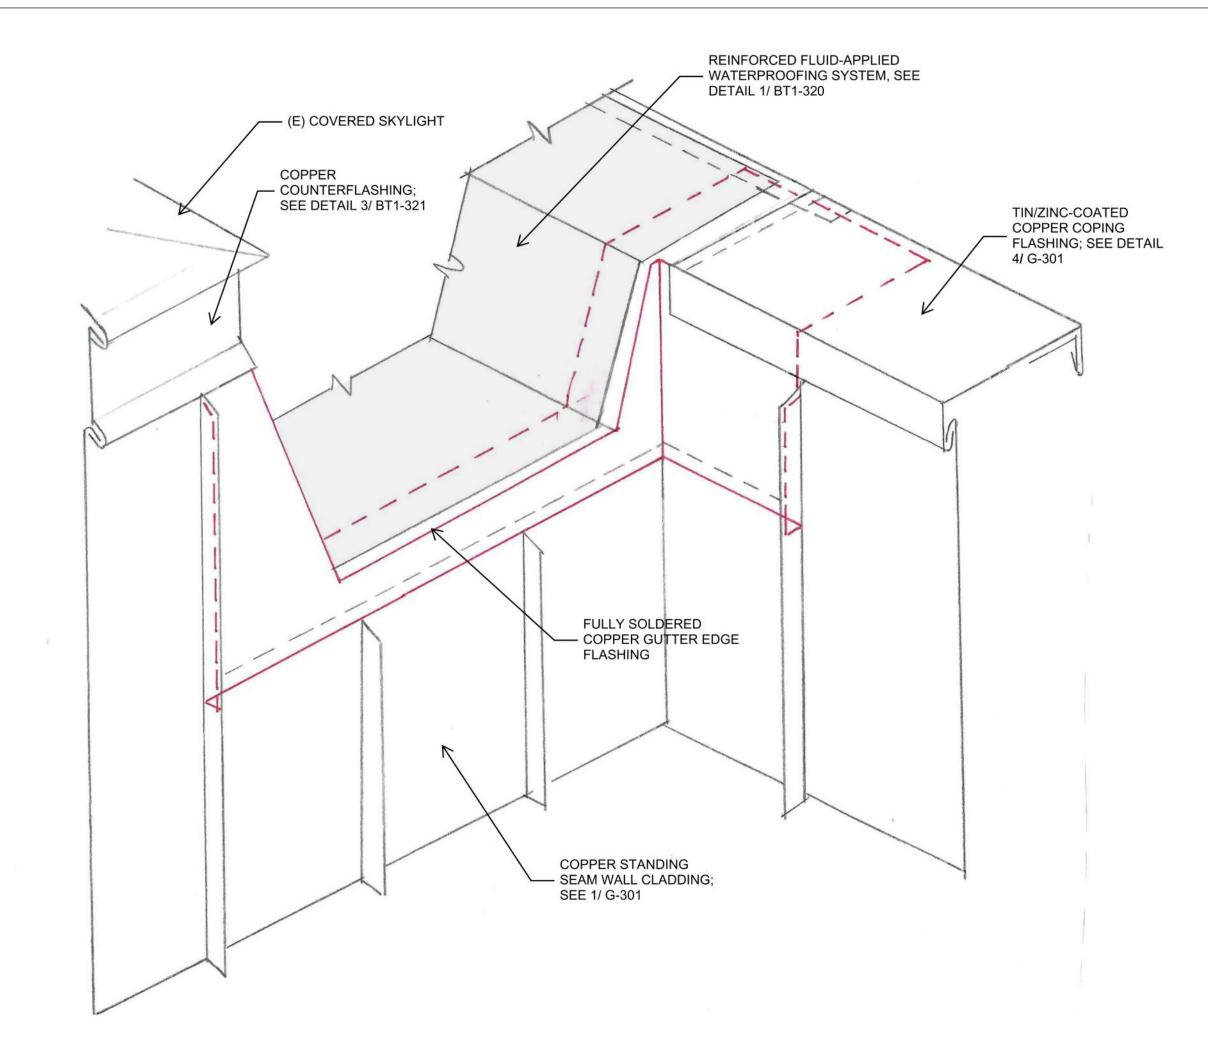
Phase 1, Complete per Decision 22AUG2022



FLUID-APPLIED WATERPROOFING TO METAL PANEL TRANSITION

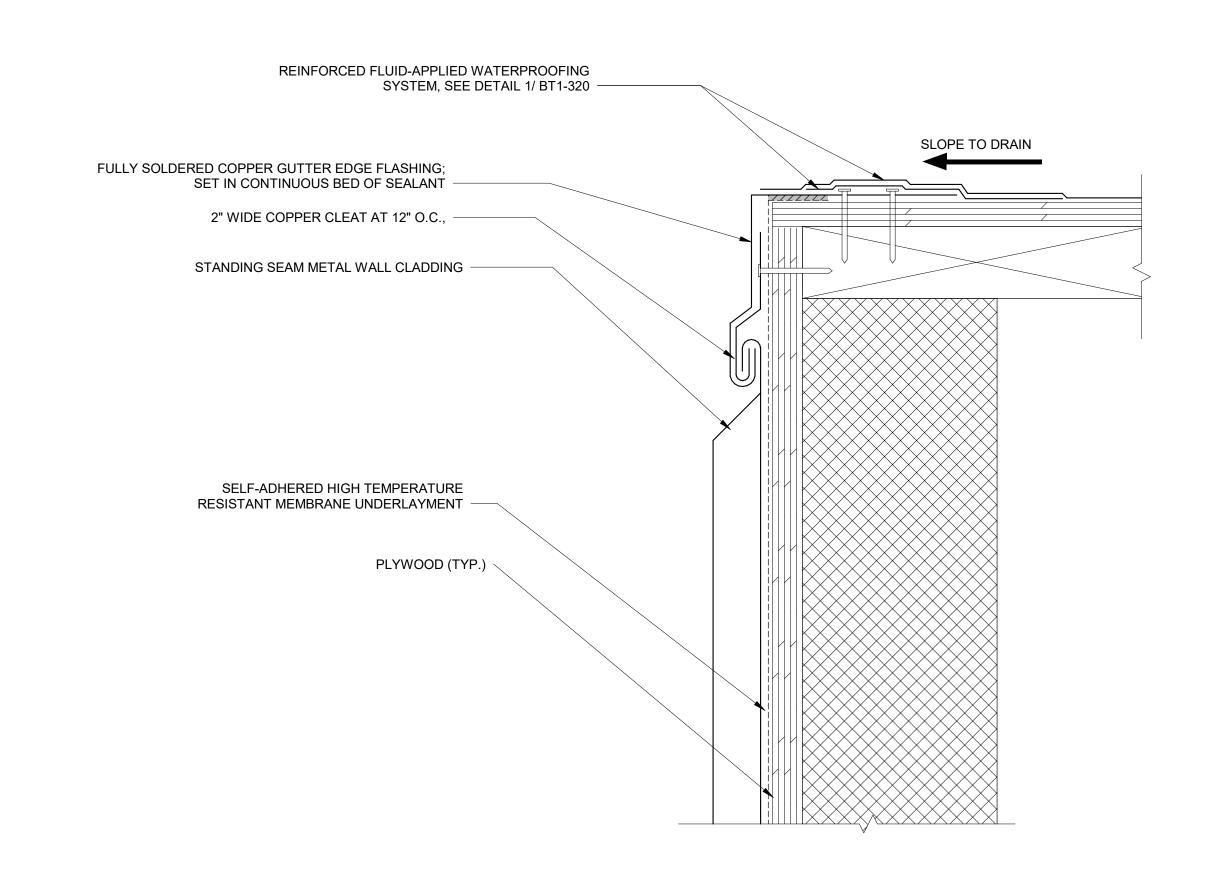

TYPICAL STANDING SEAM COVERED SKYLIGHT EDGE




GUTTER TRANSITION TO STANDING SEAM CLADDING

NTS



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5	7/22/22	PHASE 1 AND 2 - PERMIT SET
4	03/31/22	PHASE 3 - 90% CDs
3	02/11/22	PHASE 1 AND 2 BID SET
2	12/16/21	50% CONSTRUCTION DOCUMENTS
1	10/28/21	100% DESIGN DEVELOPMENT
No.	Date	Description

1930s Building Roof & Fuller Lab Envelope Improvements

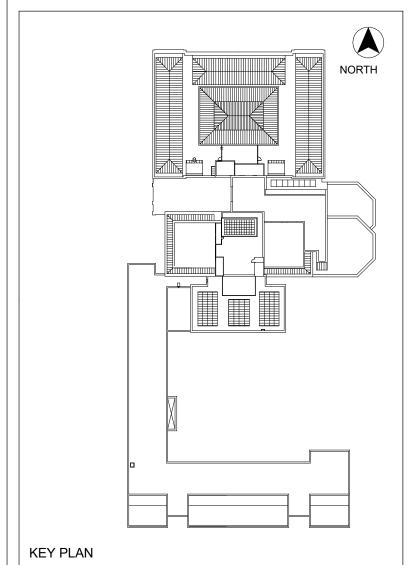WORCESTER ART MUSEUM WORCESTER, MA

Project

PHASE 1

BUILT-IN GUTTER AND FLASHING DETAILS

Drawing Title

Project No. Checked Date 7/22/2022


Drawn Approved Scale As indicated Drawing No.

BT1-321

Seal

/2022 10:35:09 AM

Phase 1, Complete per Decision 22AUG2022

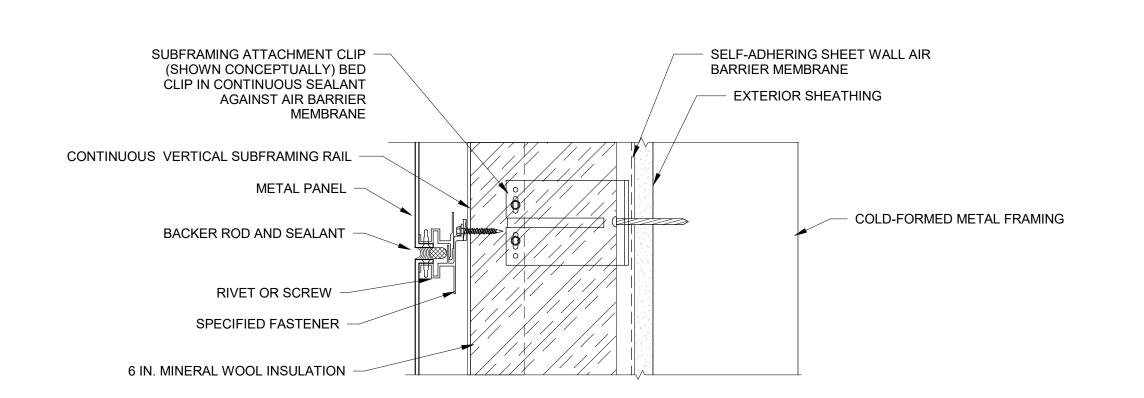


SEALANT CANT AT ALL INSIDE CORNERS (TYP.) TYPICAL METAL PANEL WALL ASSEMBLY; DETAIL 1/BT1-330 METAL TERMINATION BAR TO -SECURE EDGE OF AIR BARRIER MEMBRANE (TYP.). SEAL OVER TERMINATION BAR AND LEADING MEMBRANE EDGE (TYP.) BACKER ROD AND SEALANT


TYPICAL METAL PANEL WALL ASSEMBLY; DETAIL 1/BT1-330 METAL THROUGH-WALL 12 IN. O.C. SELF-ADHERED HIGH TEMPERATURE RESISTANT MEMBRANE UNDERLAYMENT HOOK STRIP (E) CONCRETE SLAB


METAL PANEL WALL ASSEMBLY

2 METAL PANEL INFILL JAMB

METAL PANEL INFILL BASE OF WALL

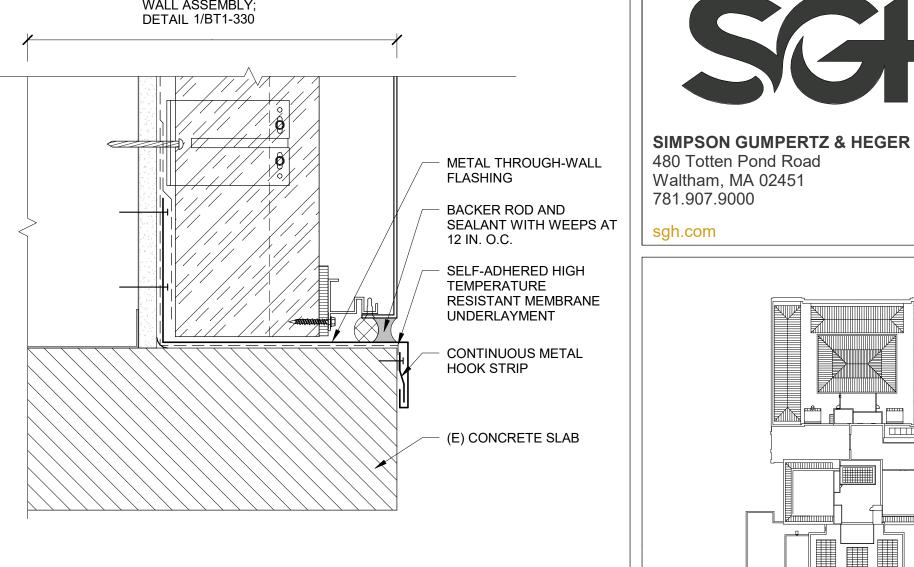

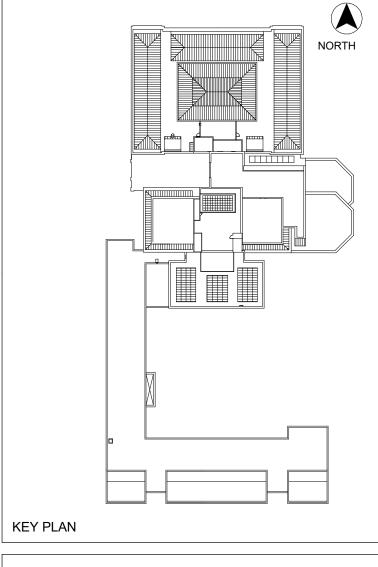

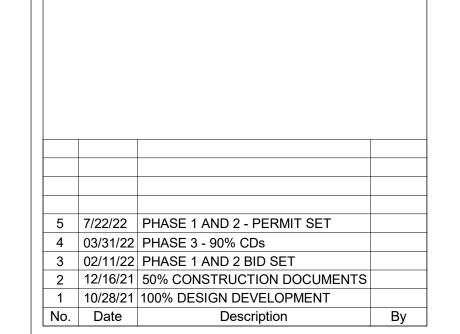



WORCESTER ART MUSEUM WORCESTER, MA


PHASE 1

Checked

METAL PANEL INFILL DETAILS

10608.00	CCW		7/22/2022
)rawn EM/BBS/MAW	Approved JSD		Scale As indicated
		Drawing N	No.

BT1-330

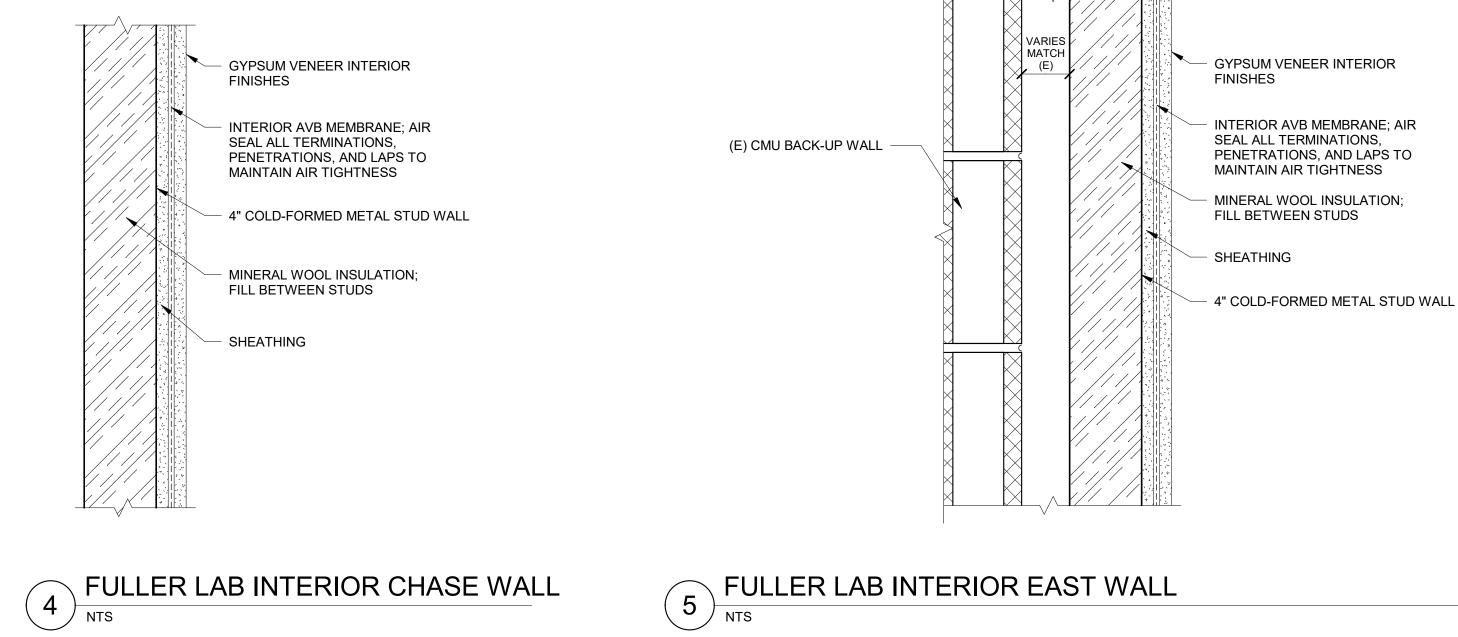

5 FULLER LAB INTERIOR EAST WALL


UHPC CLADDING AT CMU BACKUP WALL

JAMB PANNING BEYOND DOUBLE-HUNG WINDOW FRAME SILL FLASHING END DAM; COUNTERFLASH WITH JAMB MEMBRANE FLASHING PROVIDE SEALANT BETWEEN FRAME AND FLASHING AND BETWEEN UHPC JAMB RETURN PANEL BEYOND -FLASHING AND MEMBRANE SELF-ADHERED HIGH TEMPERATURE CONTINUOUS INTERIOR TRIM RESISTANT MEMBRANE UNDERLAYMENT DISCRETE PLASTIC SHIM BACKER ROD AND SEALANT WITH TWO WEEPS PER SILL WOOD STOOL FULLY-SOLDERED TIN-ZINC COATED SLOPED WOOD SHIM COPPER SILL FLASHING WITH UPTURNED WOOD BLOCKING LEG AND INTERIOR AND END DAMS AT **JAMBS** APPROXIMATE EXTENT OF INTERIOR FINISHES. ASSUME REMOVAL AND REPLACEMENT OF 1'-0" (E) INTERIOR NOTES:

1. WOOD BLOCKING SHOWN FINISHES ARE REQUIRED SCHEMATICALLY. ASSUME 2x (E) CMU BACK-UP WALL BLOCKING REQUIRED AT ROUGH WINDOW OPENING PERIMETER TYPICAL UHPC CLADDING SYSTEM; SEE DETAIL 1/ BT1-340

MECHANICAL ROOM WINDOW SILL


NTS

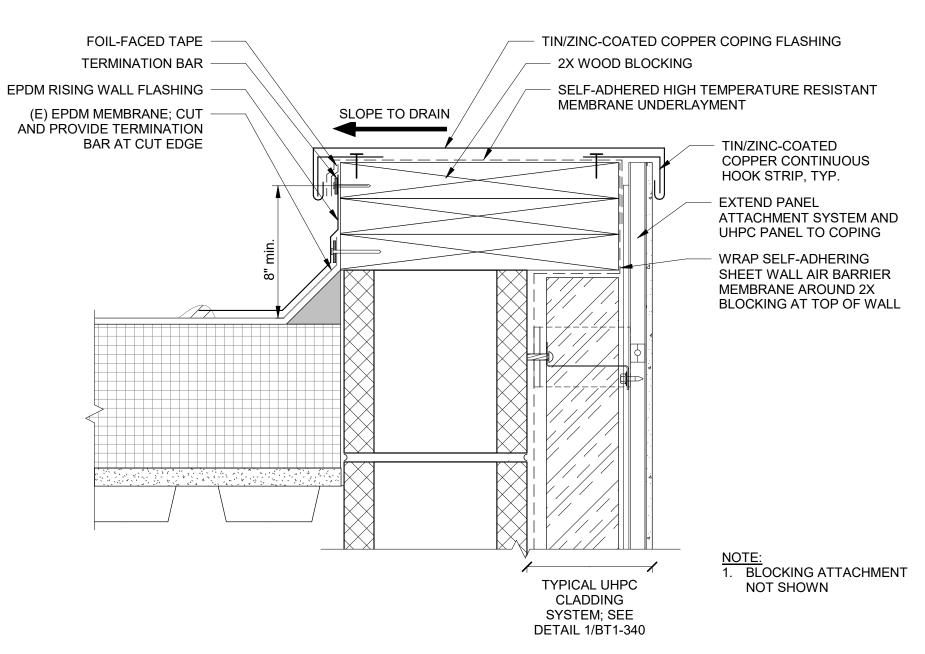

APPROXIMATE EXTENT OF INTERIOR FINISHES. ASSUME CONTINUOUS INTERIOR TRIM REMOVAL AND REPLACEMENT OF 1'-0" (E) INTERIOR FINISHES EDGE OF SILL STOOL BELOW ARE REQUIRED WRAP SELF-ADHERING SHEET WALL AIR BARRIER MEMBRANE LAP OVER MEMBRANE FLASHING AND METAL FLASHING END DAMS DISCRETE PLASTIC SHIMS BACKER ROD AND SEALANT TYPICAL UHPC CLADDING; SEE DETAIL 1/BT1-340 DOUBLE-HUNG WINDOW FRAME EXTERIOR TRIM WITH QUARETER ROUND PANNING EDGE OF SILL PANNING BELOW NOTES:

1. WOOD BLOCKING AT WINDOW BACKER ROD AND SEALANT PERIMETER NOT SHOWN BUT MAY BE REQUIRED. ASSUME 2x BLOCKING REQUIRED AT ROUGH

MECHANICAL ROOM WINDOW JAMB

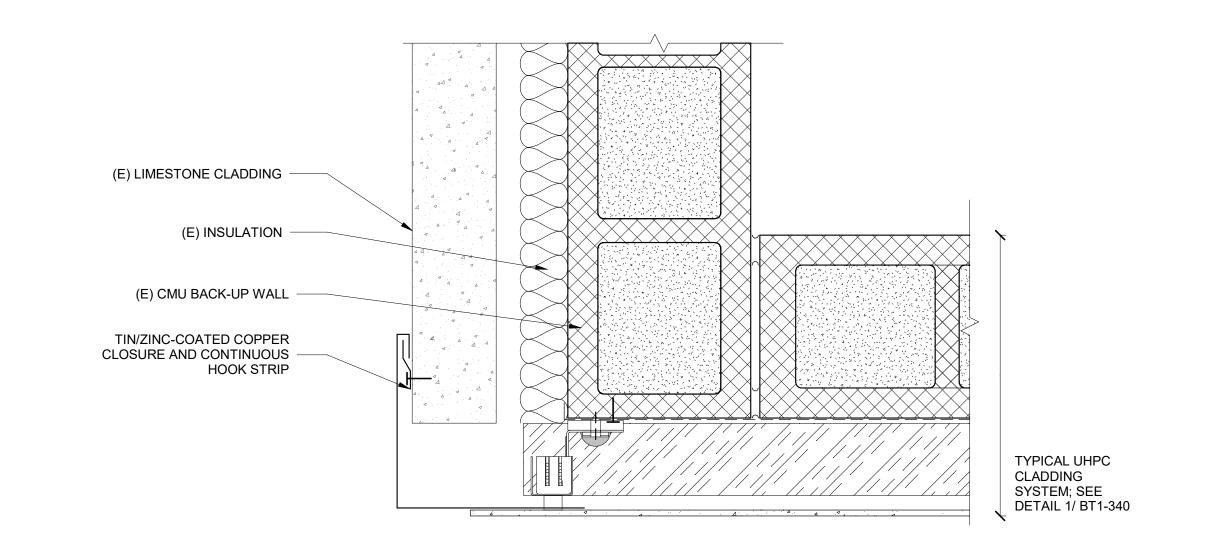


UHPC CLADDING TRANSITION TO (E) LIMESTONE CLADDING

NTS

Phase 1, Complete per Decision 22AUG2022

WINDOW OPENING PERIMETER



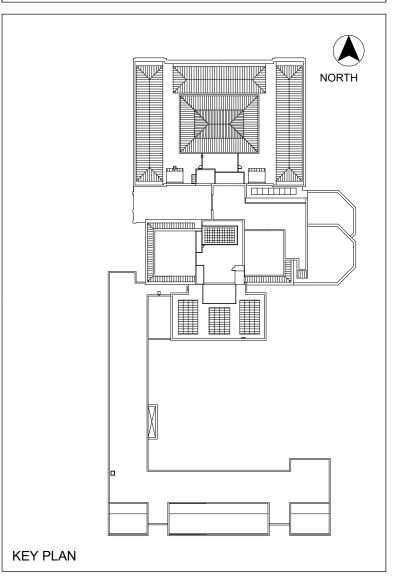

5 7/22/22 PHASE 1 AND 2 - PERMIT SET
4 03/31/22 PHASE 3 - 90% CDs
3 02/11/22 PHASE 1 AND 2 BID SET
2 12/16/21 50% CONSTRUCTION DOCUMENTS
1 10/28/21 100% DESIGN DEVELOPMENT
No. Date Description By

1930s Building Roof & Fuller Lab Envelope Improvements

WORCESTER ART MUSEUM WORCESTER, MA

Project

PHASE 1

PENTHOUSE CLADDING
DETAILS

Drawing Title


Project No. Checked Date 7/22/2022

Drawn Approved Scale As indicated Drawing No.

BT1-340


7/22/2022 10:35:11 AM

5 UHPC TOP OF WALL

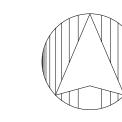



PROJECT NORTH

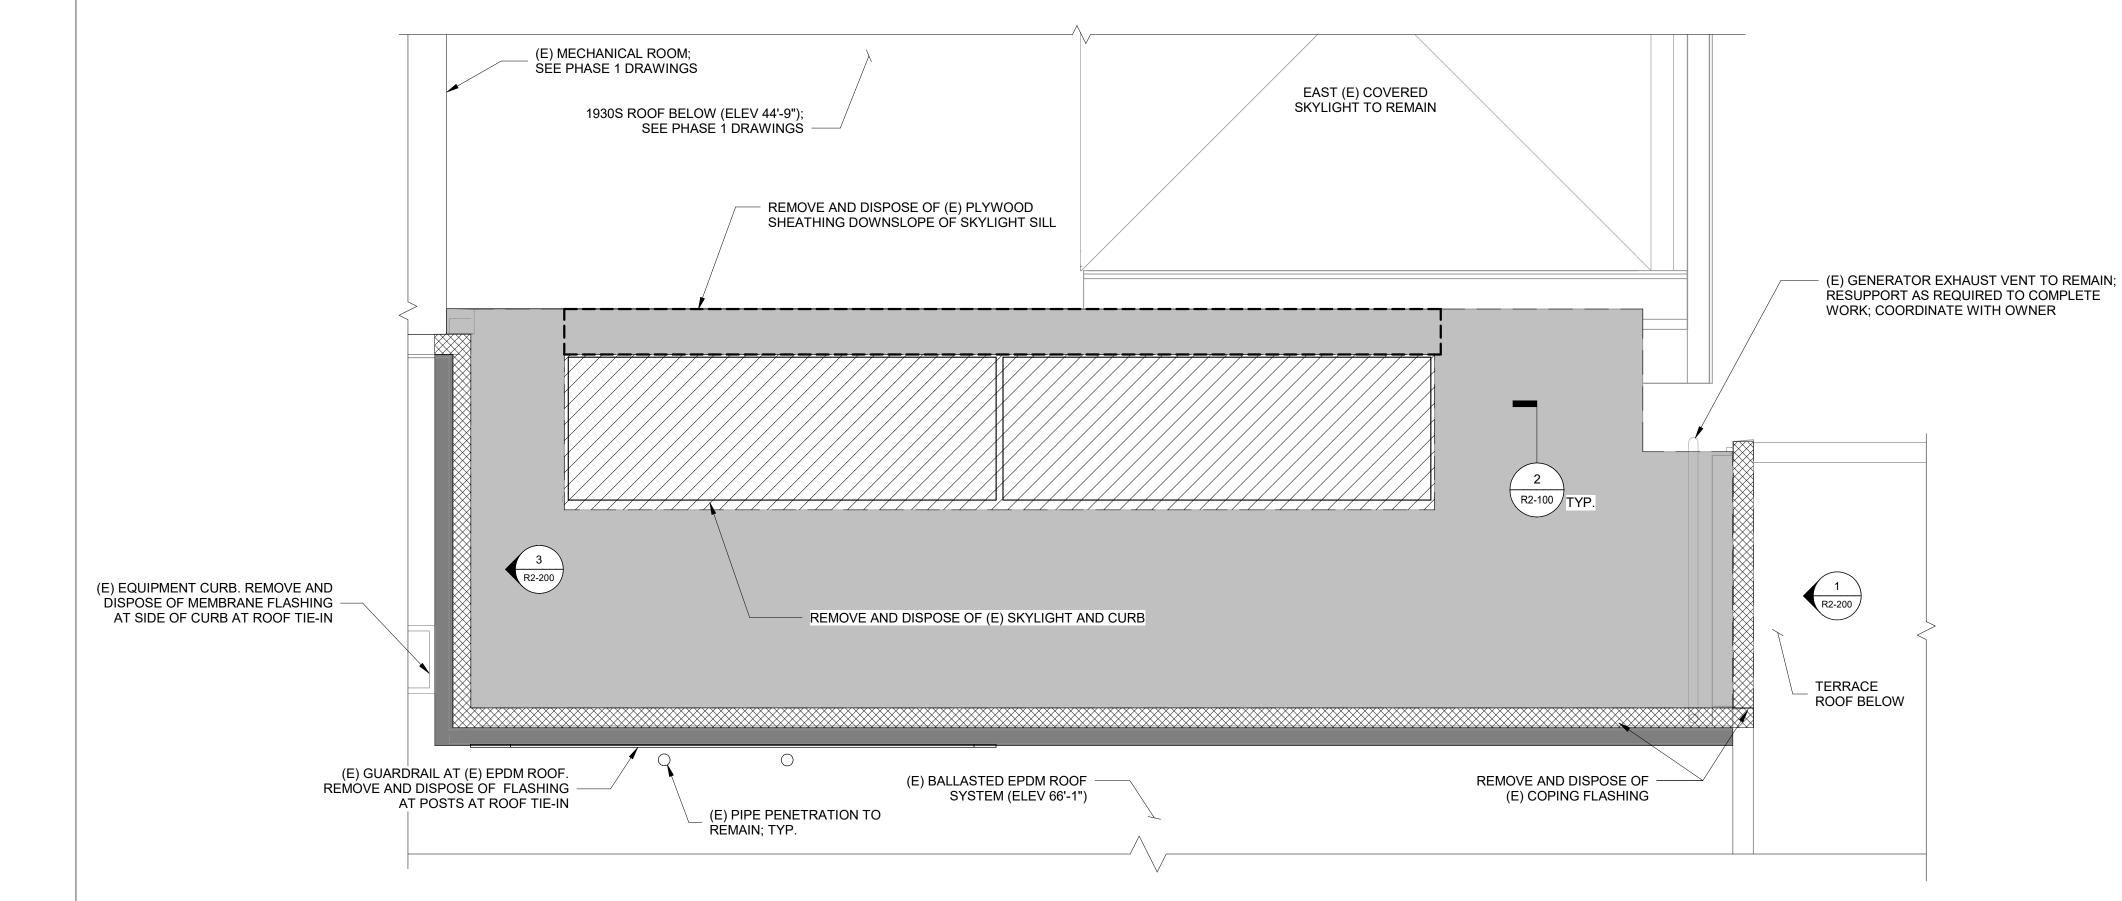

LEGEND

- REMOVE AND DISPOSE OF (E) STANDING SEAM ROOF SYSTEM. REFER TO DETAIL 2/ R2-100. REMOVE AND DISPOSE OF PLYWOOD SHEATHING AT LOCATIONS NOTES ON PLAN
- REMOVE AND DISPOSE OF (E) METAL FLASHING AND UNDERLAYMENT
- REMOVE AND DISPOSE OF (E) BALLASTED EPDM ROOF SYSTEM
- REMOVE AND DISPOSE OF (E) SKYLIGHT, FLASHING, FRAME, AND CURB

- REMOVE AND DISPOSE OF (E) LEAD-COATED COPPER STANDING SEAM METAL ROOF SYSTEM, INCLUDING UNDERLAYMENT, TO THE (E) PLYWOOD SHEATHING. REMOVE (E) FLASHING AT PERIMETERS, TERMINATIONS, AND RISING WALLS. REMOVE AND DISPOSE OF (E) PLYWOOD SHEATHING DOWNSLOPE OF SKYLIGHT SILL.
- REMOVE AND DISPOSE OF (E) SKYLIGHT, INCLUDING AT GLAZING SKYLIGHT FRAMING, AND THE (E) CURB. REMOVE AND DISPOSE OF INTERIOR FINISHES AT SKYLIGHT CURB; ASSUME 2'-0" AT SKYLIGHT PERIMETER.
- REMOVE AND DISPOSE OF INTERIOR FINISHES TO EXPOSE (E) STRUCTURAL STEEL TO VERIFY BEAM AND CONDITIONS; ASSUME 30 SF. SEE STRUCTURAL DRAWINGS.

- 1. PROVIDE TEMPORARY PROTECTION AS REQUIRED DURING REMOVALS TO MAINTAIN WEATHER-TIGHTNESS AND STRUCTURAL INTEGRITY.
- DIMENSIONS, RELATIVE ELEVATIONS, SCALE, ETC. ARE SHOWN FOR REFERENCE ONLY. CONTRACTOR TO VERIFY ALL DIMENSIONS IN FIELD PRIOR TO BIDDING.
- HAZARDOUS MATERIALS: HAZARDOUS MATERIALS FOUND IN PROJECT AREA. COORDINATE WITH ABATEMENT DRAWINGS AND REQUIREMENTS OF OWNER'S HAZARDOUS MATERIALS CONSULTANT.

FULLER LAB ROOF REMOVAL PLAN

REMOVE AND DISPOSE OF (E) LEAD-COATED COPPER STANDING SEAM ROOF REMOVE AND DISPOSE OF (E) UNDERLAYMENT (E) PLYWOOD TO REMAIN, EXCEPT AT LOCATIONS NOTED ON PLAN (E) METAL DECK TO REMAIN


WHC, Area of Interest
Phase 2: Fuller Conservation Lab Roof & Skylight Replacement

(E) STANDING SEAM ROOFING SYSTEM



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4	03/31/22	PHASE 3 - 90% CDs
3	02/11/22	PHASE 1 AND 2 BID SET
2	12/16/21	50% CONSTRUCTION DOCUMENTS
1	10/28/21	100% DESIGN DEVELOPMENT
No.	Date	Description

1930s Building Roof & Fuller Lab Envelope **Improvements**

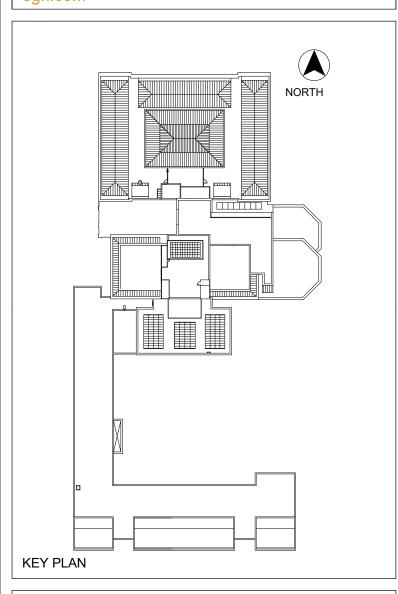
> **WORCESTER ART MUSEUM** WORCESTER, MA

PHASE 2

FULLER ROOF REMOVAL PLAN

Project No.	Checked		Date
210608.00	CCW		7/22/2022
Drawn	Approved		Scale
KEM/BBS/MAW	JSD		As indicated
		Drawing N	No.


R2-100

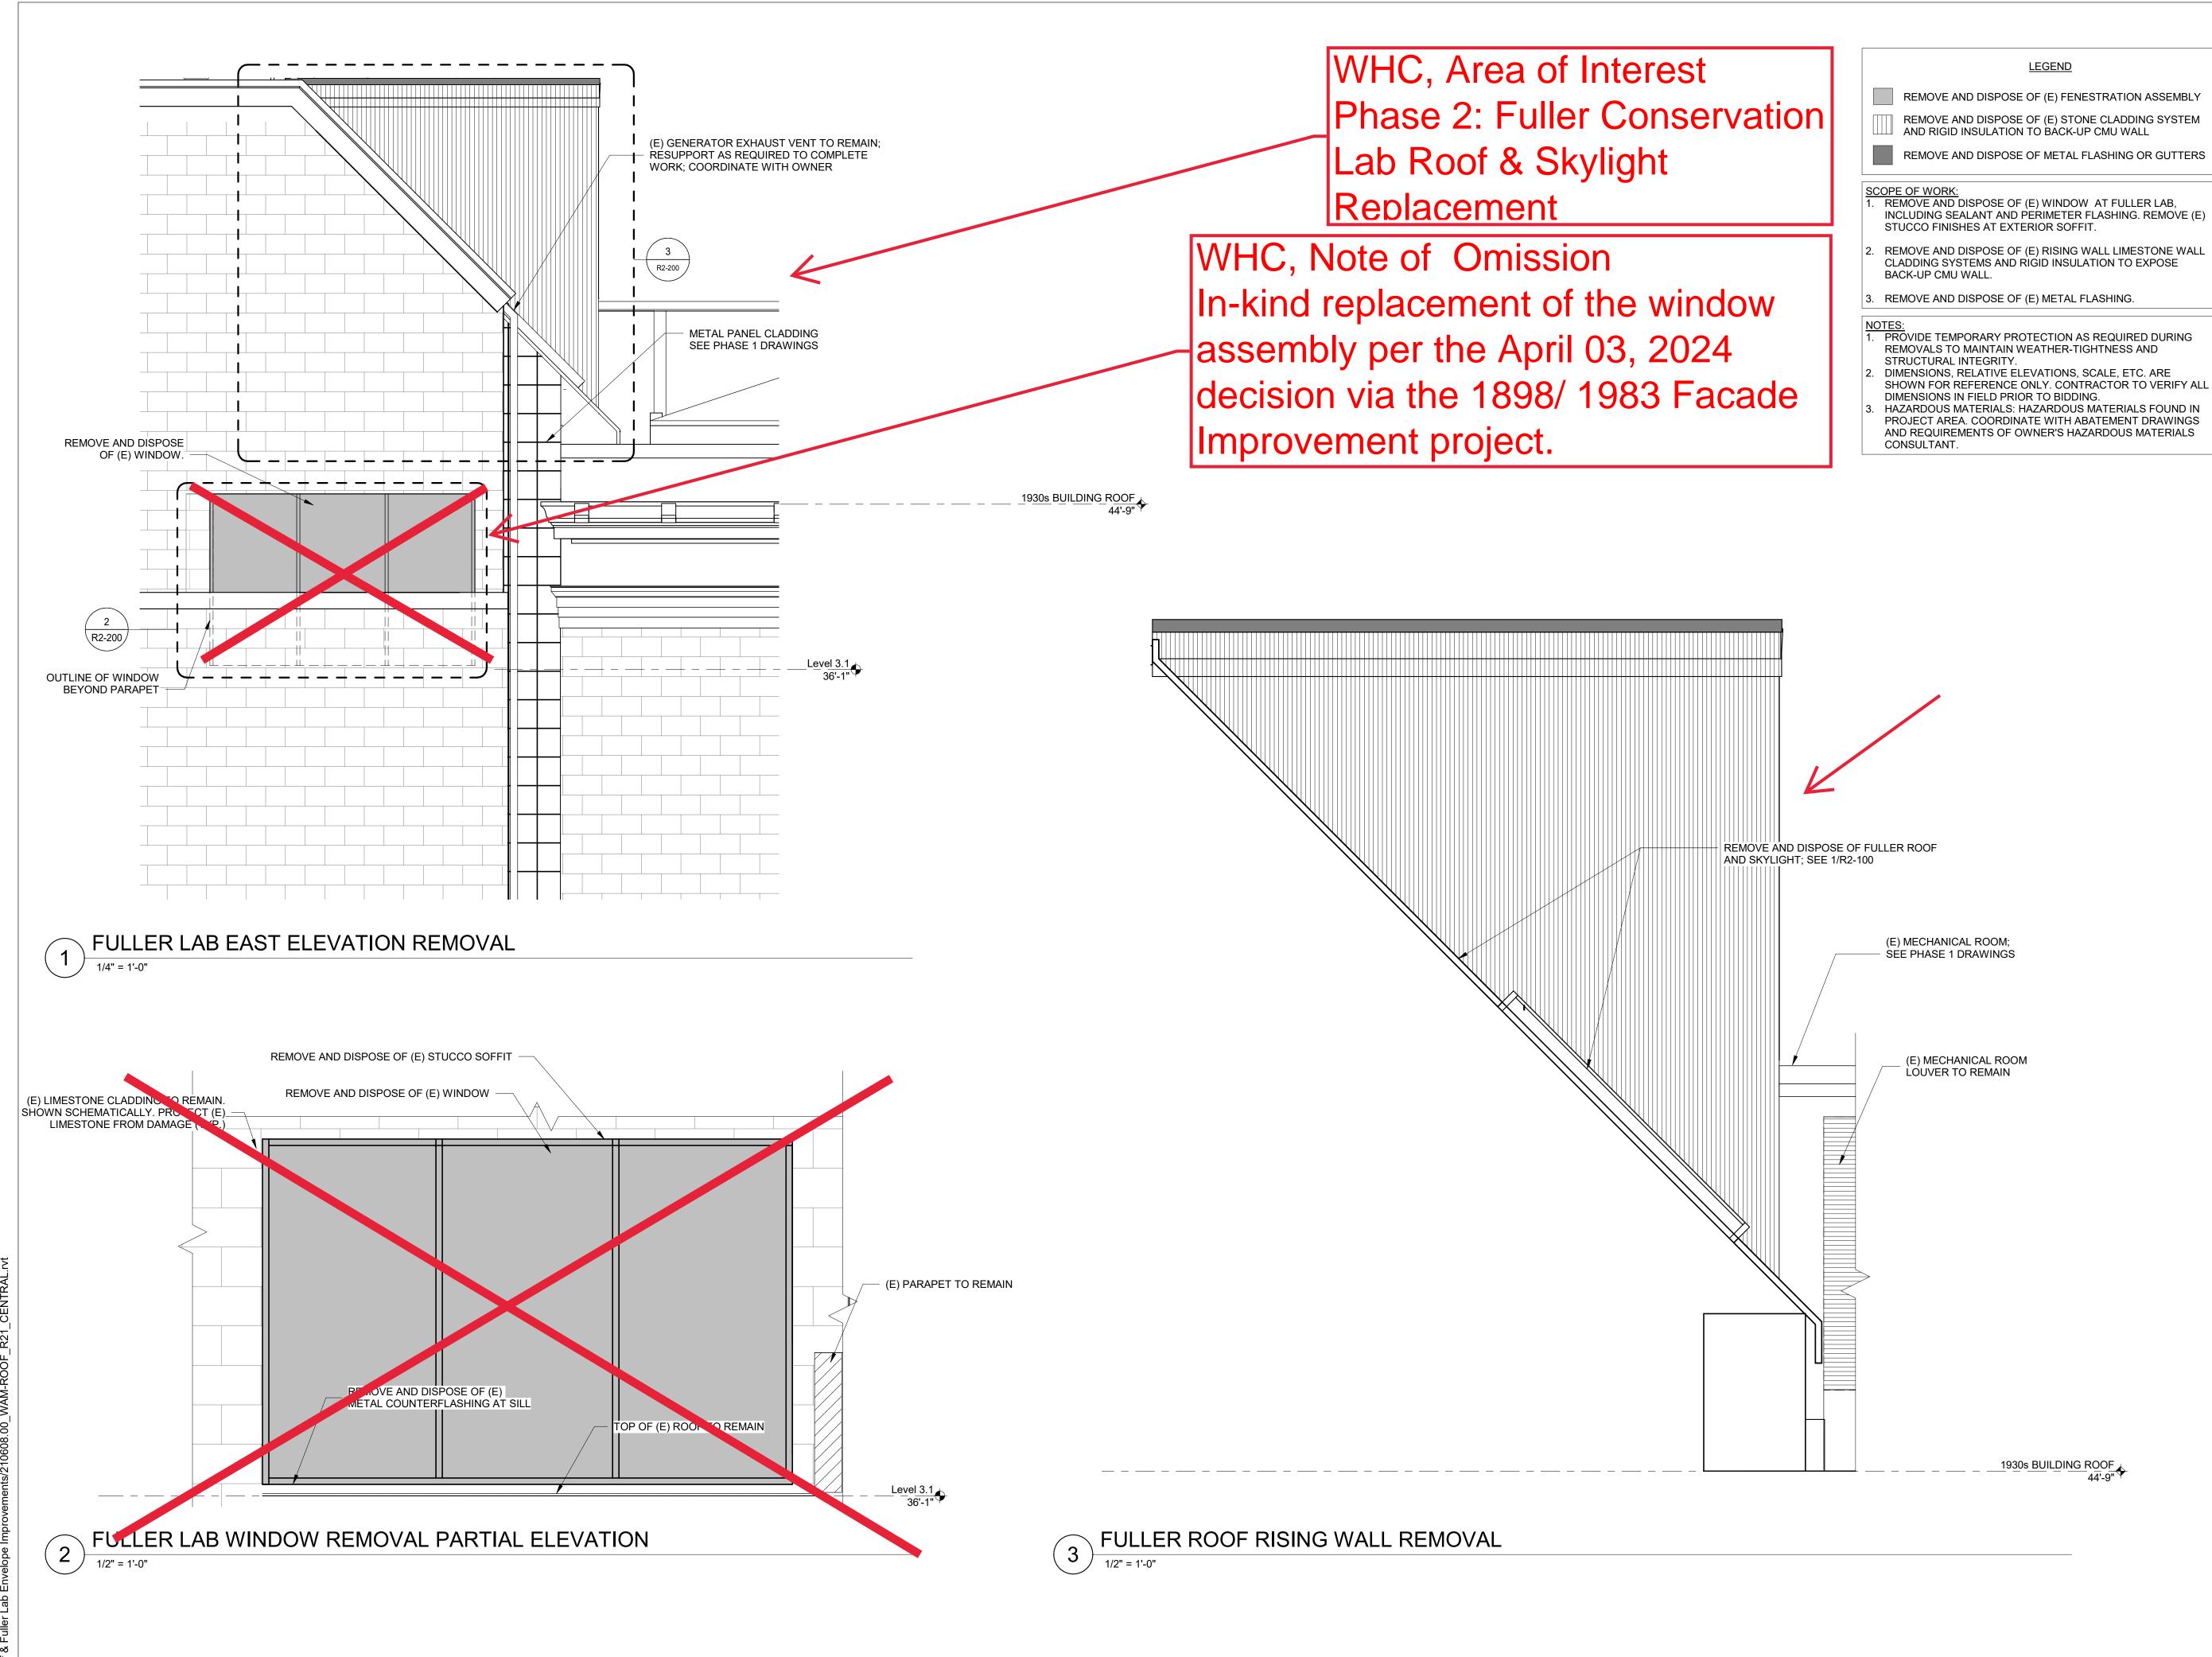



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5	7/22/22	PHASE 1 AND 2 - PERMIT SET	
4	03/31/22	PHASE 3 - 90% CDs	
3	02/11/22	PHASE 1 AND 2 BID SET	
2	12/16/21	50% CONSTRUCTION DOCUMENTS	
1	10/28/21	100% DESIGN DEVELOPMENT	
No.	Date	Description	Ву

1930s Building Roof & Fuller Lab Envelope Improvements

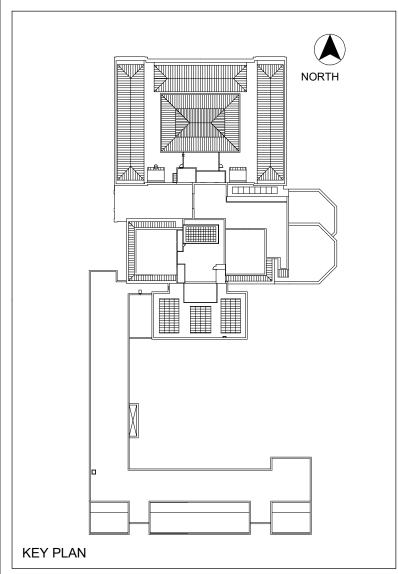WORCESTER ART MUSEUM WORCESTER, MA

Proje

PHASE 2


FULLER LAB REMOVAL ELEVATIONS

Drawing Title

210608.00	CCW		7/22/2022
Drawn KEM/BBS/MAW	Approved JSD		Scale As indicated
		Drawing N	No.

R2-200

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WHC, Note of Omission
Per previous notes, this scope is omitted, both curtain wall and window assembly.

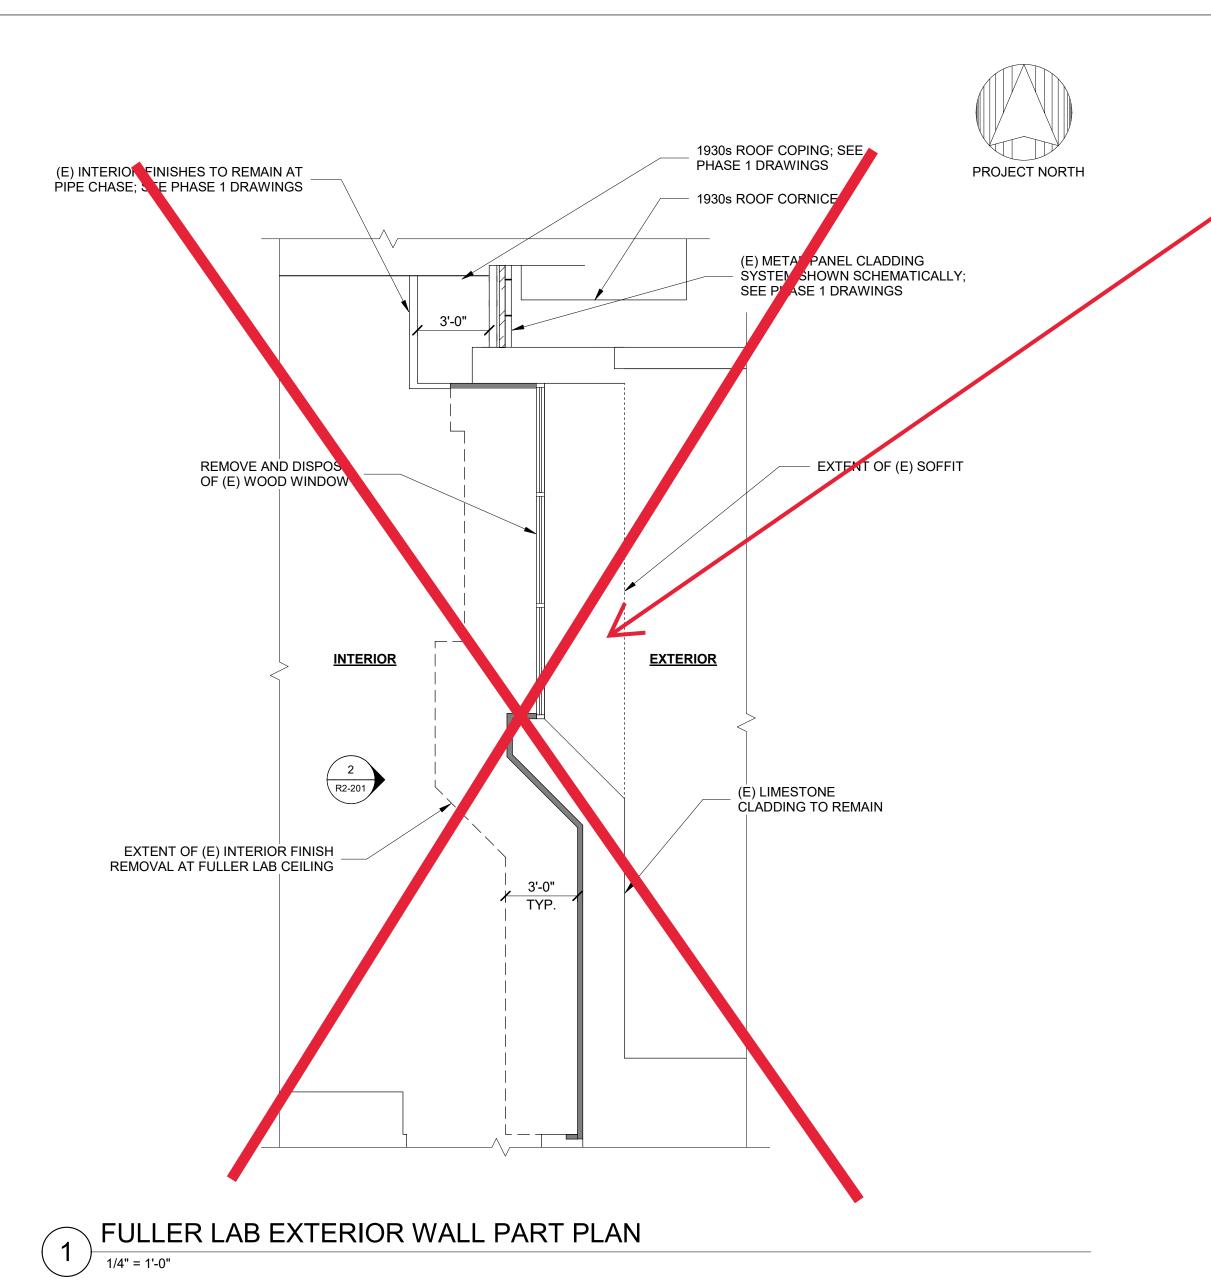LEGEND

REMOVE AND DISPOSE OF (E) INTERIOR FINISHES AND INSULATION BETWEEN (E) COLD-FORMED FRAMING STUDS

REMOVE AND DISPOSE OF (E) FENESTRATION ASSEMBLY

SCOPE OF WORK:

1. REMOVE AND DISPOSE OF (E) WINDOW AT FULLER LAB, INCLUDING SEALANT PERIMETER FLASHING AND INTERIOR FINISHES AROUND PERIMETER.

REMOVE AND DISPOSE OF (E) INTERIOR WALL AND CEILING FINISHES TO (E) COLD-FORMED FRAMING AT LOCATIONS SHOWN ON THE DRAWINGS.


NOTES:

1. PROVIDE TEMPORARY PROTECTION AS REQUIRED DURING REMOVALS TO MAINTAIN WEATHER-TIGHTNESS AND STRUCTURAL INTEGRITY. DIMENSIONS, RELATIVE ELEVATIONS, SCALE, ETC. ARE SHOWN FOR REFERENCE ONLY. CONTRACTOR TO VERIFY ALL DIMENSIONS IN FIELD PRIOR TO BIDDING.

3. HAZARDOUS MATERIALS: HAZARDOUS MATERIALS FOUND IN PROJECT AREA. COORDINATE WITH ABATEMENT DRAWINGS AND REQUIREMENTS OF OWNER'S HAZARDOUS MATERIALS CONSULTANT.

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5	7/22/22	PHASE 1 AND 2 - PERMIT SET	
4	03/31/22	PHASE 3 - 90% CDs	
3	02/11/22	PHASE 1 AND 2 BID SET	
2	12/16/21	50% CONSTRUCTION DOCUMENTS	
1	10/28/21	100% DESIGN DEVELOPMENT	
No.	Date	Description	Ву

1930s Building Roof & Fuller Lab Envelope **Improvements**
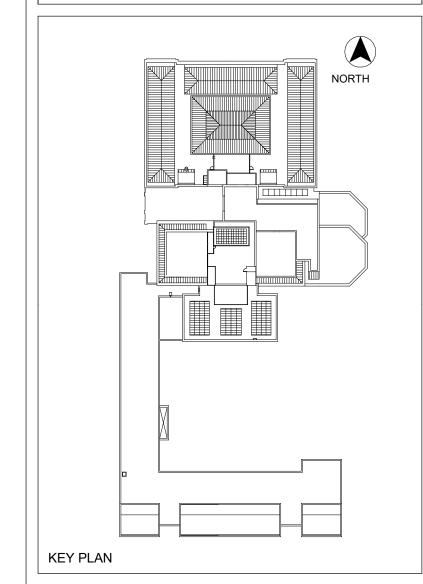
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PHASE 2 **FULLER LAB WALL PART PLAN AND INTERIOR** REMOVAL ELEVATION


Project No.	Checked	Date
210608.00	CCW	7/22/2022
Drawn	Approved	Scale
KEM/BBS/MAW	JSD	As indicated
	Drawing I	No.

R2-201

(E) INTERIOR FINISHES TO REMAIN AT PIPE CHASE; SEE PHASE 1 DRAWINGS REMOVE AND DISPOSE OF (E) WOOD WINDOW TOP OF FLOOR FINISHES TO REMAIN Level 3.1 36' - 1"


FULLER LAB PARTIAL INTERIOR ELEVATION

1/2" = 1'-0"

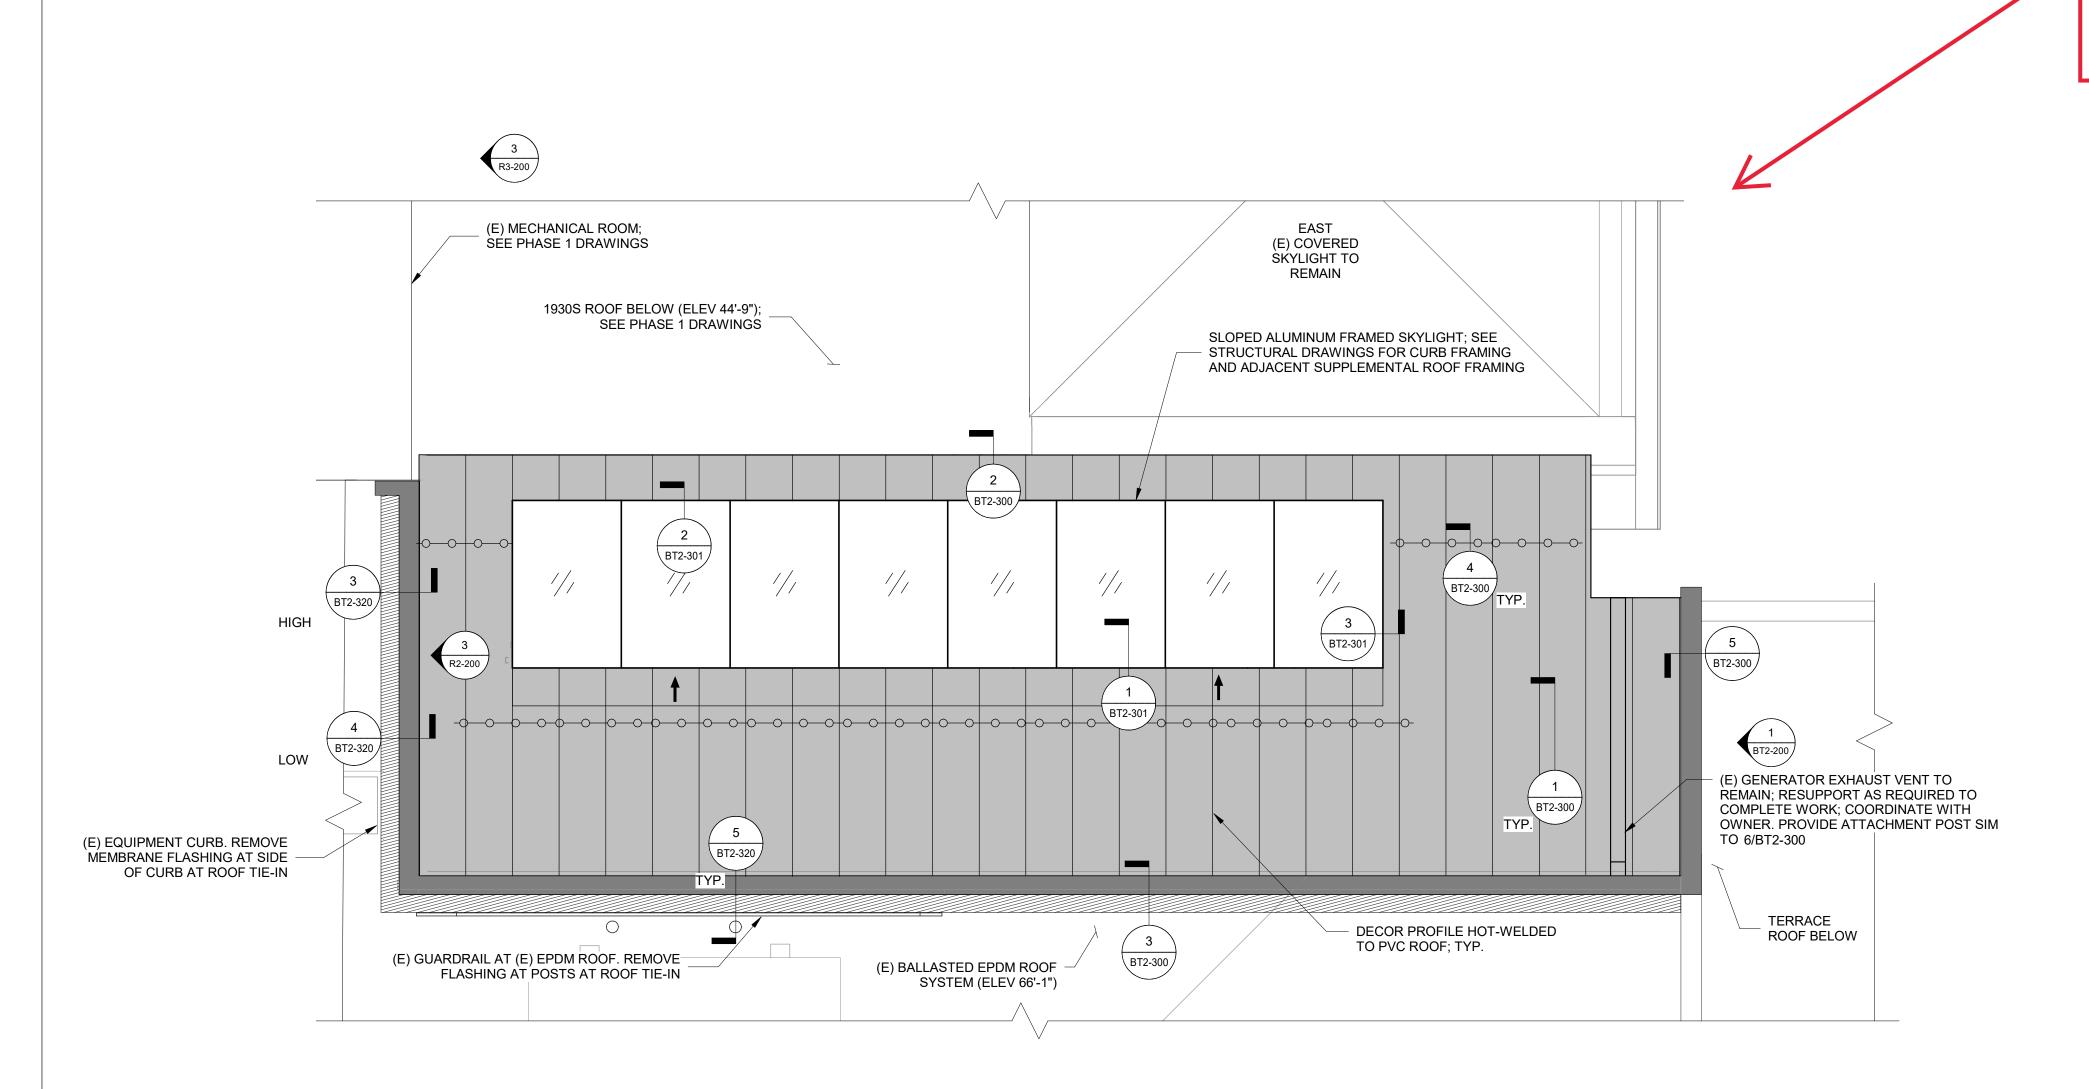

WHC, Area of Interest
Phase 2: Fuller Conservation
Lab Roof & Skylight Replacement


LEGEND

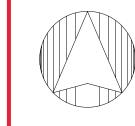



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5 | 7/22/22 | PHASE 1 AND 2 - PERMIT SET 4 03/31/22 PHASE 3 - 90% CDs 3 02/11/22 PHASE 1 AND 2 BID SET

2 12/16/21 50% CONSTRUCTION DOCUMENTS

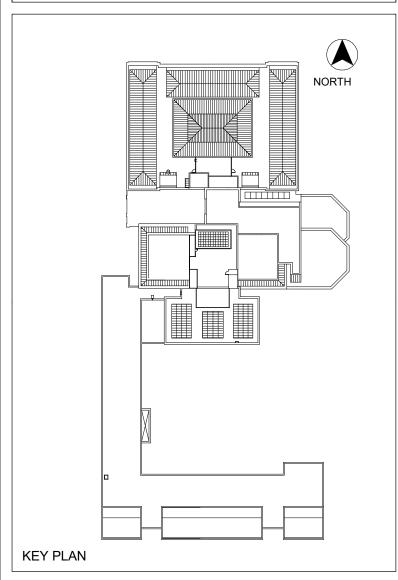1 | 10/28/21 | 100% DESIGN DEVELOPMENT

1930s Building Roof & Fuller Lab Envelope **Improvements**

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PHASE 2

FULLER ROOF PLAN

	Project No.	Checked	Date
	210608.00	CCW	7/22/2022
	Drawn KEM/BBS/MAW	Approved JSD	Scale As indicated
l		Drawing I	No.

BT2-100

FULLER ROOF PLAN


SLOPED PVC ROOF SYSTEM WITH DECOR PROFILE TIN/ZINC-COATED COPPER COPING FLASHING (E) EPDM ROOF TIE-IN TO ADJACENT ROOF REPLACEMENT —O—O— SNOW RETENTION SYSTEM SEE; 4/BT2-300 → SLOPE TO DRAIN; MIN. 1/2" PER FT. FULLER LAB ROOF SCOPE OF WORK:

1. PROVIDE SLOPED PVC ROOF SYSTEM, INCLUDING SELF-ADHERED VAPOR RETARDER, INSULATION, COVERBOARD, AND ADHERED PVC MEMBRANE WITH DECOR PROFILE. PROVIDE PVC-COATED METAL FLASHING AND TIN/ZINC-COATED COPPER FLASHING. REPLACE DETERIORATED AREAS OF (E) PLYWOOD; REPLACE PLYWOOD SHEATHING DOWNSLOPE OF SKYLIGHT SILL AND ASSUME AN ADDITIONAL 10% REQUIRES REPLACEMENT. ALLOW ENGINEER TO REVIEW IN THE FIELD BEFORE COVERING. . PROVIDE SLOPED ALUMINUM FRAMED SKYLIGHT WITH TRIPLE-GLAZED IGUS. PROVIDE PERIMETER CURB AND BLOCKING; SEE STRUCTURAL DRAWING FOR STEEL CURB FRAMING. PROVIDE PERIMETER AIR SEALS, MINERAL WOOL INSULATION, AND ALUMINUM FRAMING. PROVIDE REPLACEMENT INTERIOR FINISHES AT SKYLIGHT PERIMETER. 4. PROVIDE INTERIOR FINISHES WHERE REMOVED TO VERIFY (E) STRUCTURAL STEEL; ASSUME 30 SF. SEE STRUCTURAL NOTES:

1. PROTECT ALL SURROUNDING FINISHES AND STRUCTURE TO

2. DIMENSIONS, MEMBER SIZES, EXISTING FRAMING CONFIGURATIONS, RELATIVE ELEVATIONS, SCALE, ETC. ARE SHOWN FOR REFERENCE ONLY. CONTRACTOR TO VERIFY ALL

DIMENSIONS IN FIELD PRIOR TO BIDDING. HAZARDOUS MATERIALS: HAZARDOUS MATERIALS FOUND IN PROJECT AREAS. COORDINATE WITH ABATEMENT DRAWINGS AND REQUIREMENTS OF OWNER'S HAZARDOUS MATERIALS CONSULTANT.

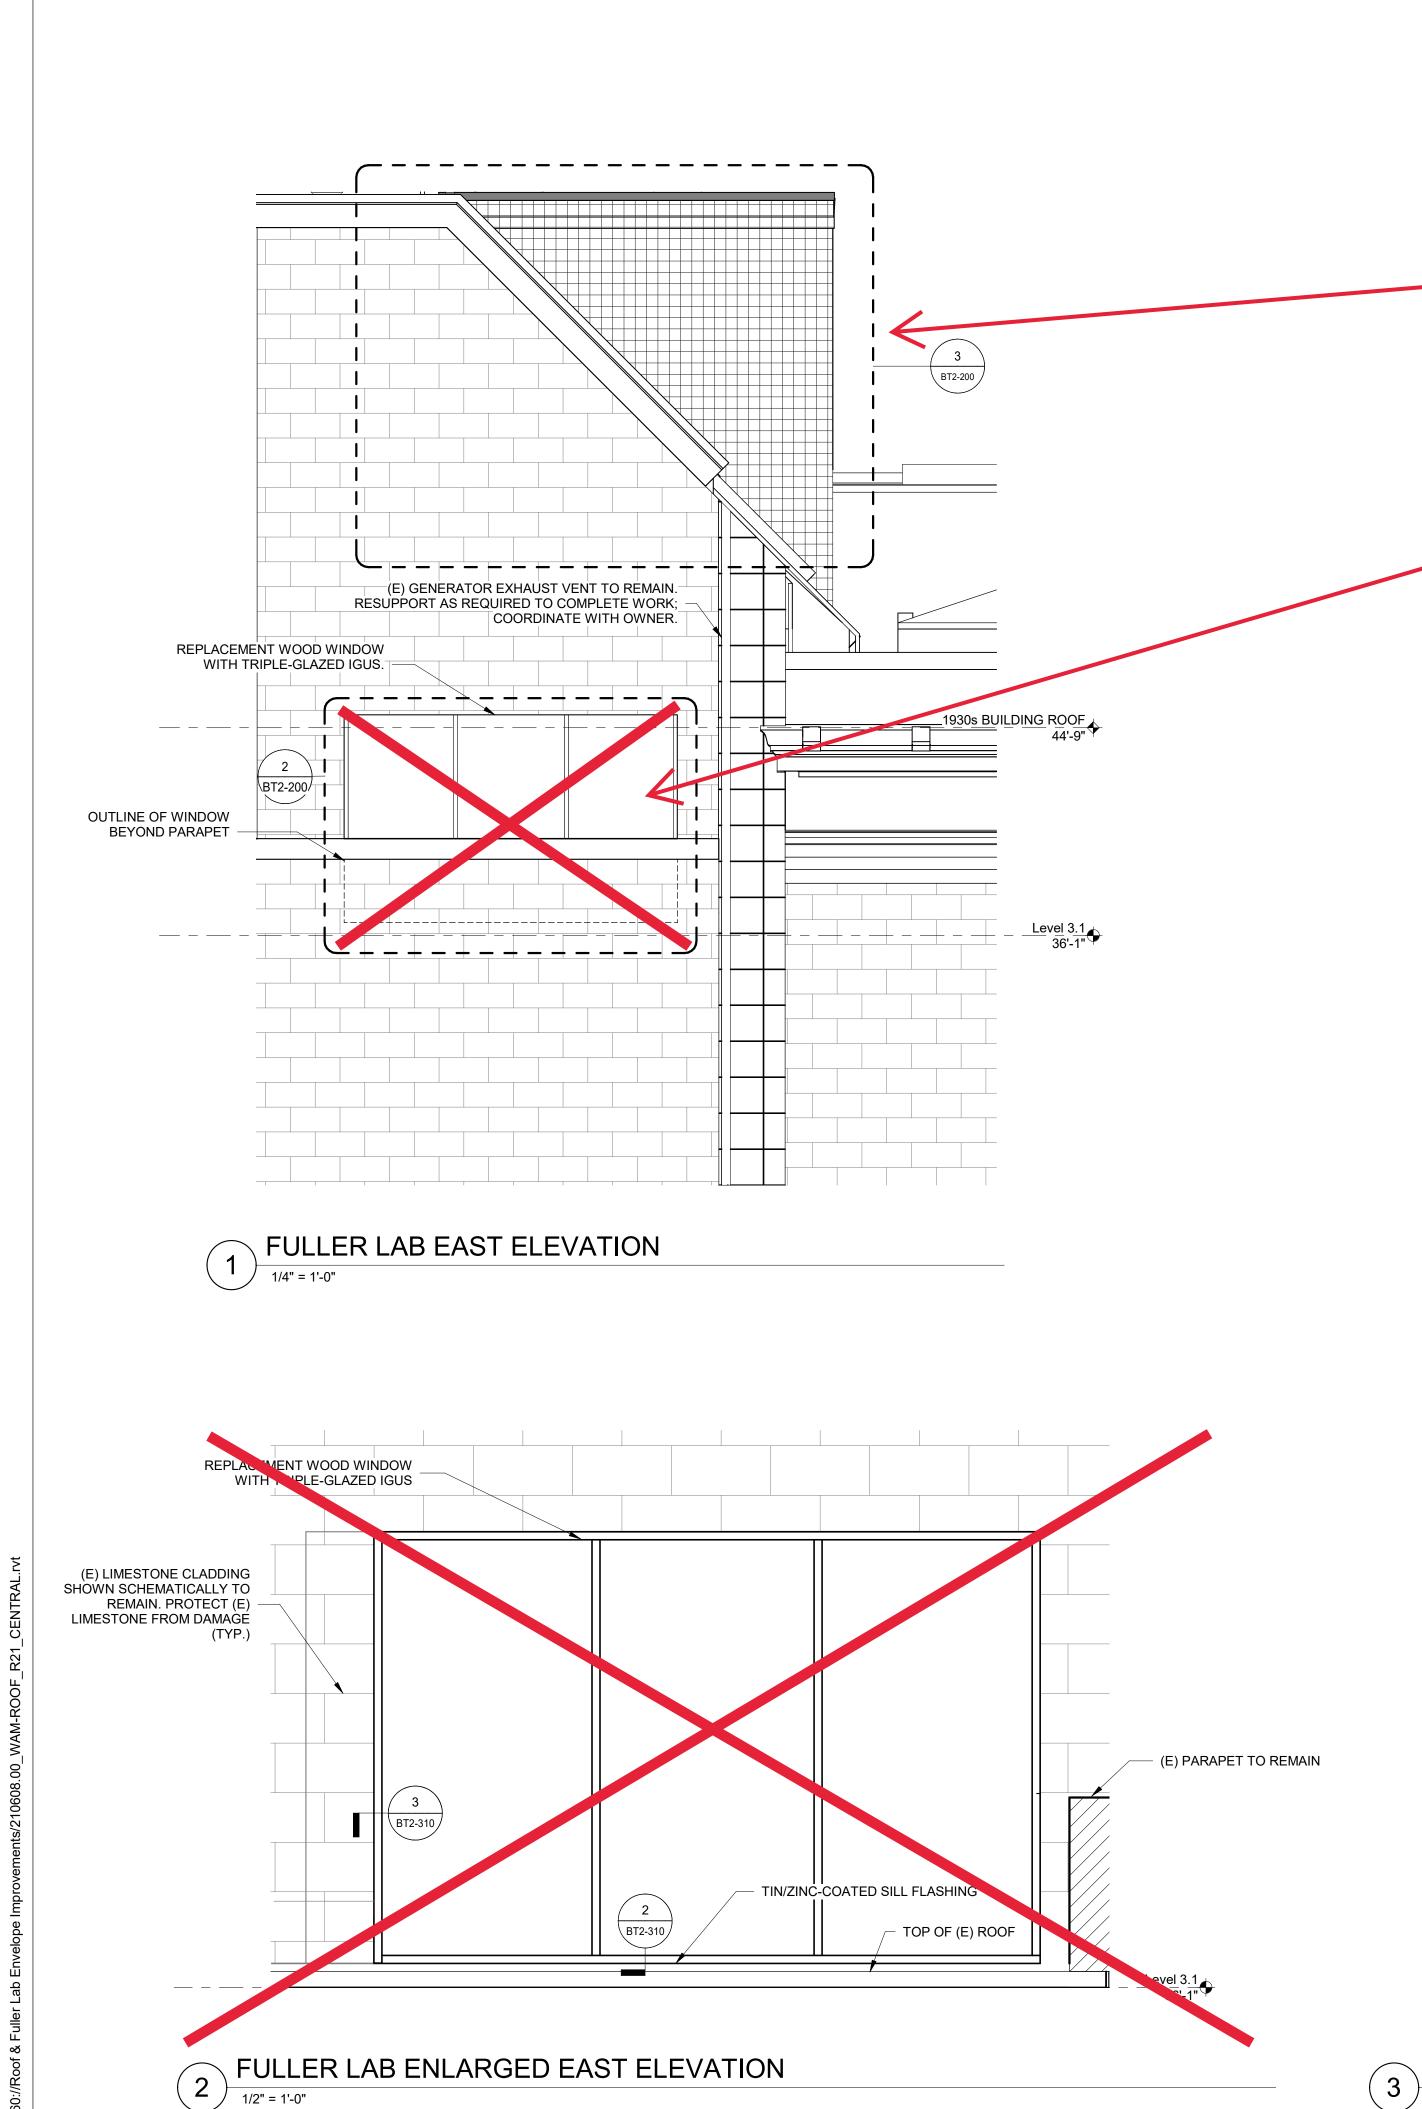

WHC, Area of Interest Phase 2: Fuller Conservation Lab Roof & Skylight Replacement

LEGEND

TIN/ZINC-COATED COPPER FLASHING

UHPC CLADDING SYSTEM; SEE DETAIL 1/BT2-320

WHC, Note of Omission In-kind replacement of the window assembly per the April 03, 2024 decision via the 1898/ 1983 Facade Improvement project.

SCOPE OF WORK:

1. PROVIDE WOOD WINDOW WITH TRIPLE-GLAZED IGUS AT PUNCHED OPENING. PROVIDE SELF-ADHERING MEMBRANE FLASHING AT ROUGH OPENING, TIN/ZINC-COATED COPPER SILL FLASHING, AND BACKER ROD AND SEALANT AT WINDOW PERIMETER.

PROVIDE UHPC CLADDING SYSTEM AT (E) MECHANICAL ROOM RISING WALL, INCLUDING SELF-ADHERED AIR BARRIER, 3" MINERAL WOOL INSULATION BETWEEN DISCRETE ATTACHMENT BRACKETS, AND UHPC PANELS. (E) BACK-UP WALLS ARE CMU.

TIN/ZINC-COATED COPPER EDGE FLASHING

FULLER ROOF AND SKYLIGHT; SEE 1/BT2-100

(E) MECHANICAL ROOM; SEE PHASE 1 DRAWINGS

(E) MECHANICAL ROOM

LOUVER TO REMAIN

__1930s BUILDING ROOF


DIMENSIONS, MEMBER SIZES, EXISTING FRAMING CONFIGURATIONS, RELATIVE ELEVATIONS, SCALE, ETC. ARE SHOWN FOR REFERENCE ONLY. CONTRACTOR TO VERIFY ALL DIMENSIONS IN FIELD PRIOR TO BIDDING.

HAZARDOUS MATERIALS: HAZARDOUS MATERIALS FOUND IN PROJECT AREAS. COORDINATE WITH ABATEMENT DRAWINGS AND REQUIREMENTS OF OWNER'S HAZARDOUS MATERIALS CONSULTANT.



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5	7/22/22	PHASE 1 AND 2 - PERMIT SET	
4	03/31/22	PHASE 3 - 90% CDs	
3	02/11/22	PHASE 1 AND 2 BID SET	
2	12/16/21	50% CONSTRUCTION DOCUMENTS	
1	10/28/21	100% DESIGN DEVELOPMENT	
No.	Date	Description	Ву

1930s Building Roof & Fuller Lab Envelope **Improvements**
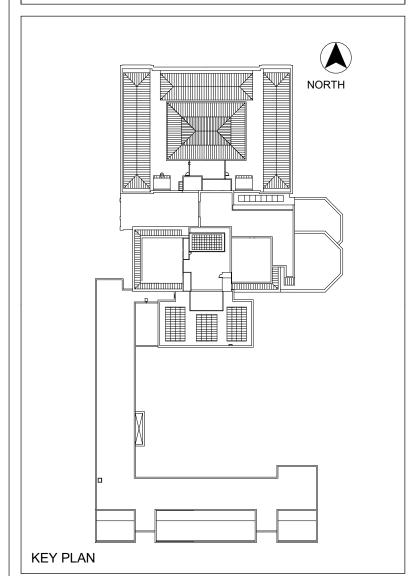
> **WORCESTER ART MUSEUM** WORCESTER, MA


PHASE 2

FULLER LAB PARTIAL ELEVATIONS

Project No. 210608.00 7/22/2022 KEM/BBS/MAW As indicated

BT2-200

FULLER HIGH ROOF - WEST ELEVATION

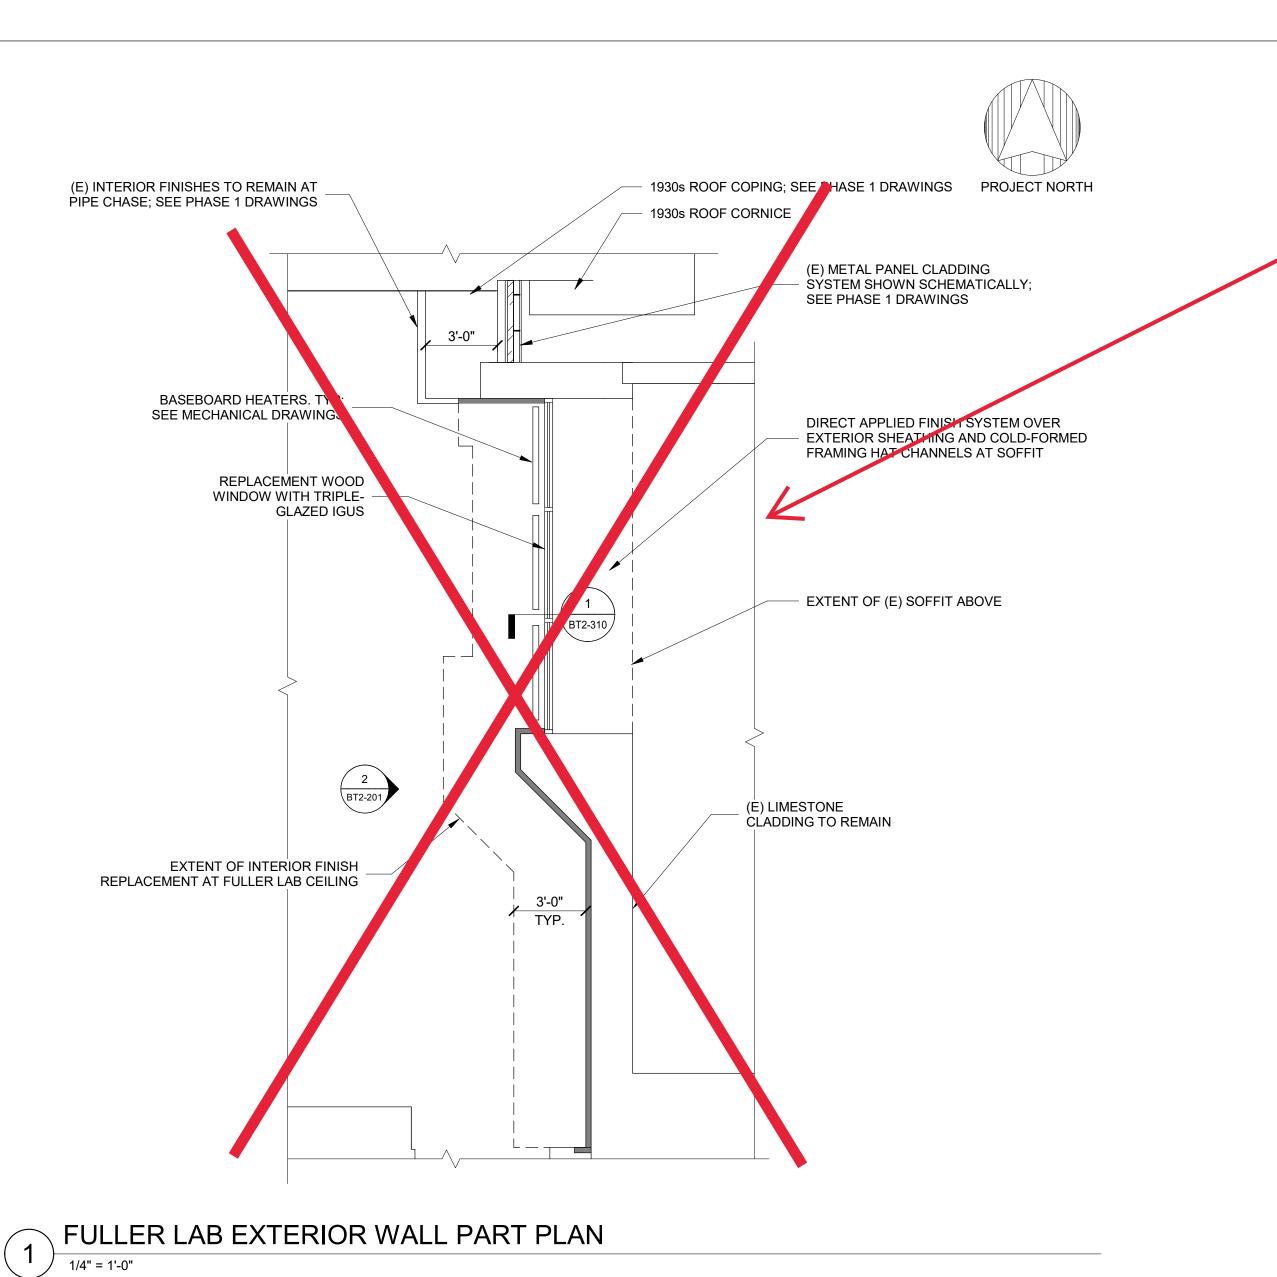

WHC, Note of Omission
Per previous notes, this scope is omitted, both curtain wall and window assembly.

LEGEND

PROVIDE MINERAL WOOL INSULATION BETWEEN STUDS, SHEATHING, INTERIOR AVB MEMBRANE, AND GYPSUM WALLBOARD INTERIOR FINISHES; SEE DETAIL 4/BT2-310

REPLACEMENT WOOD WINDOW WITH TRIPLE-GLAZED IGUS

COLD-FORMED FRAMING MINERAL WOOL INSULATION BETWEEN STUDS, INTERIOR AVB MEMBRANE

SCOPE OF WORK:

1. PROVIDE WOOD WINDOW WITH TRIPLE-GLAZING AT PUNCH WINDOW OPENING, PROVIDE SELF-ADHERING MEMBRANE FLASHING AT ROUGH OPENING, FULLY-SOLDERED TIN/ZINC-COATED COPPER SILL FLASHING, AND BACKER ROD AND SEALANT AT WINDOW PERIMETER.

PROVIDE MINERAL WOOL INSULATION BETWEEN (E) COLD-FORMED FRAMING STUDS, SHEATHING, INTERIOR AVB MEMBRANE, AND GYPSUM WALLBAORD INTERIOR FINISHES AT THE FULLER LAB INTERIOR. ABOVE THE CEILING, PROVIDE COLD-FORMED FRAMING WITH MINERAL WOOL INSULATION BETWEEN THE STUDS, SHEATHING, AND SEAL THE INTERIOR AVB MEMBRANE TO THE UNDERSIDE OF THE (E) FLOOR SLAB ABOVE AND TO STRUCTURAL STEEL. SEAL AIR BARRIER MEMBRANE TO (E) MASONRY AT END WALLS AND TO FLOOR SLAB. TIE INTERIOR FINISHES INTO (E) TO

PROVIDE COLD-FORMED FRAMING HAT CHANNELS ABOVE THE EXTERIOR SOFFIT WITH CLOSED-CELL SPRAY FOAM.


- NOTES:

 1. PROVIDE TEMPORARY PROTECTION AS REQUIRED DURING REMOVALS TO MAINTAIN WEATHER-TIGHTNESS AND STRUCTURAL INTEGRITY. DIMENSIONS, RELATIVE ELEVATIONS, SCALE, ETC. ARE SHOWN FOR REFERENCE ONLY. CONTRACTOR TO VERIFY ALL DIMENSIONS IN FIELD PRIOR TO BIDDING.
- HAZARDOUS MATERIALS: HAZARDOUS MATERIALS FOUND IN PROJECT AREA. COORDINATE WITH ABATEMENT DRAWINGS AND REQUIREMENTS OF OWNER'S HAZARDOUS MATERIALS CONSULTANT.



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KEY PLAN

5 7/22/22 PHASE 1 AND 2 - PERMIT SET 4 03/31/22 PHASE 3 - 90% CDs 3 02/11/22 PHASE 1 AND 2 BID SET 2 | 12/16/21 | 50% CONSTRUCTION DOCUMENTS 1 | 10/28/21 | 100% DESIGN DEVELOPMENT Description

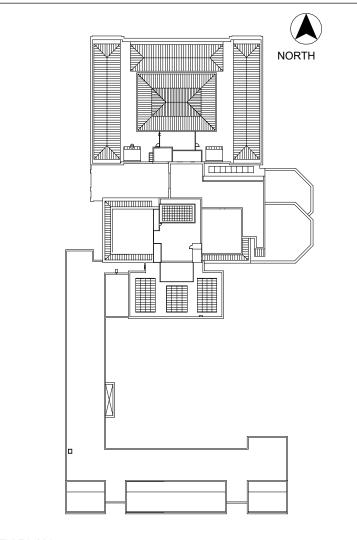
1930s Building Roof & Fuller Lab Envelope **Improvements**

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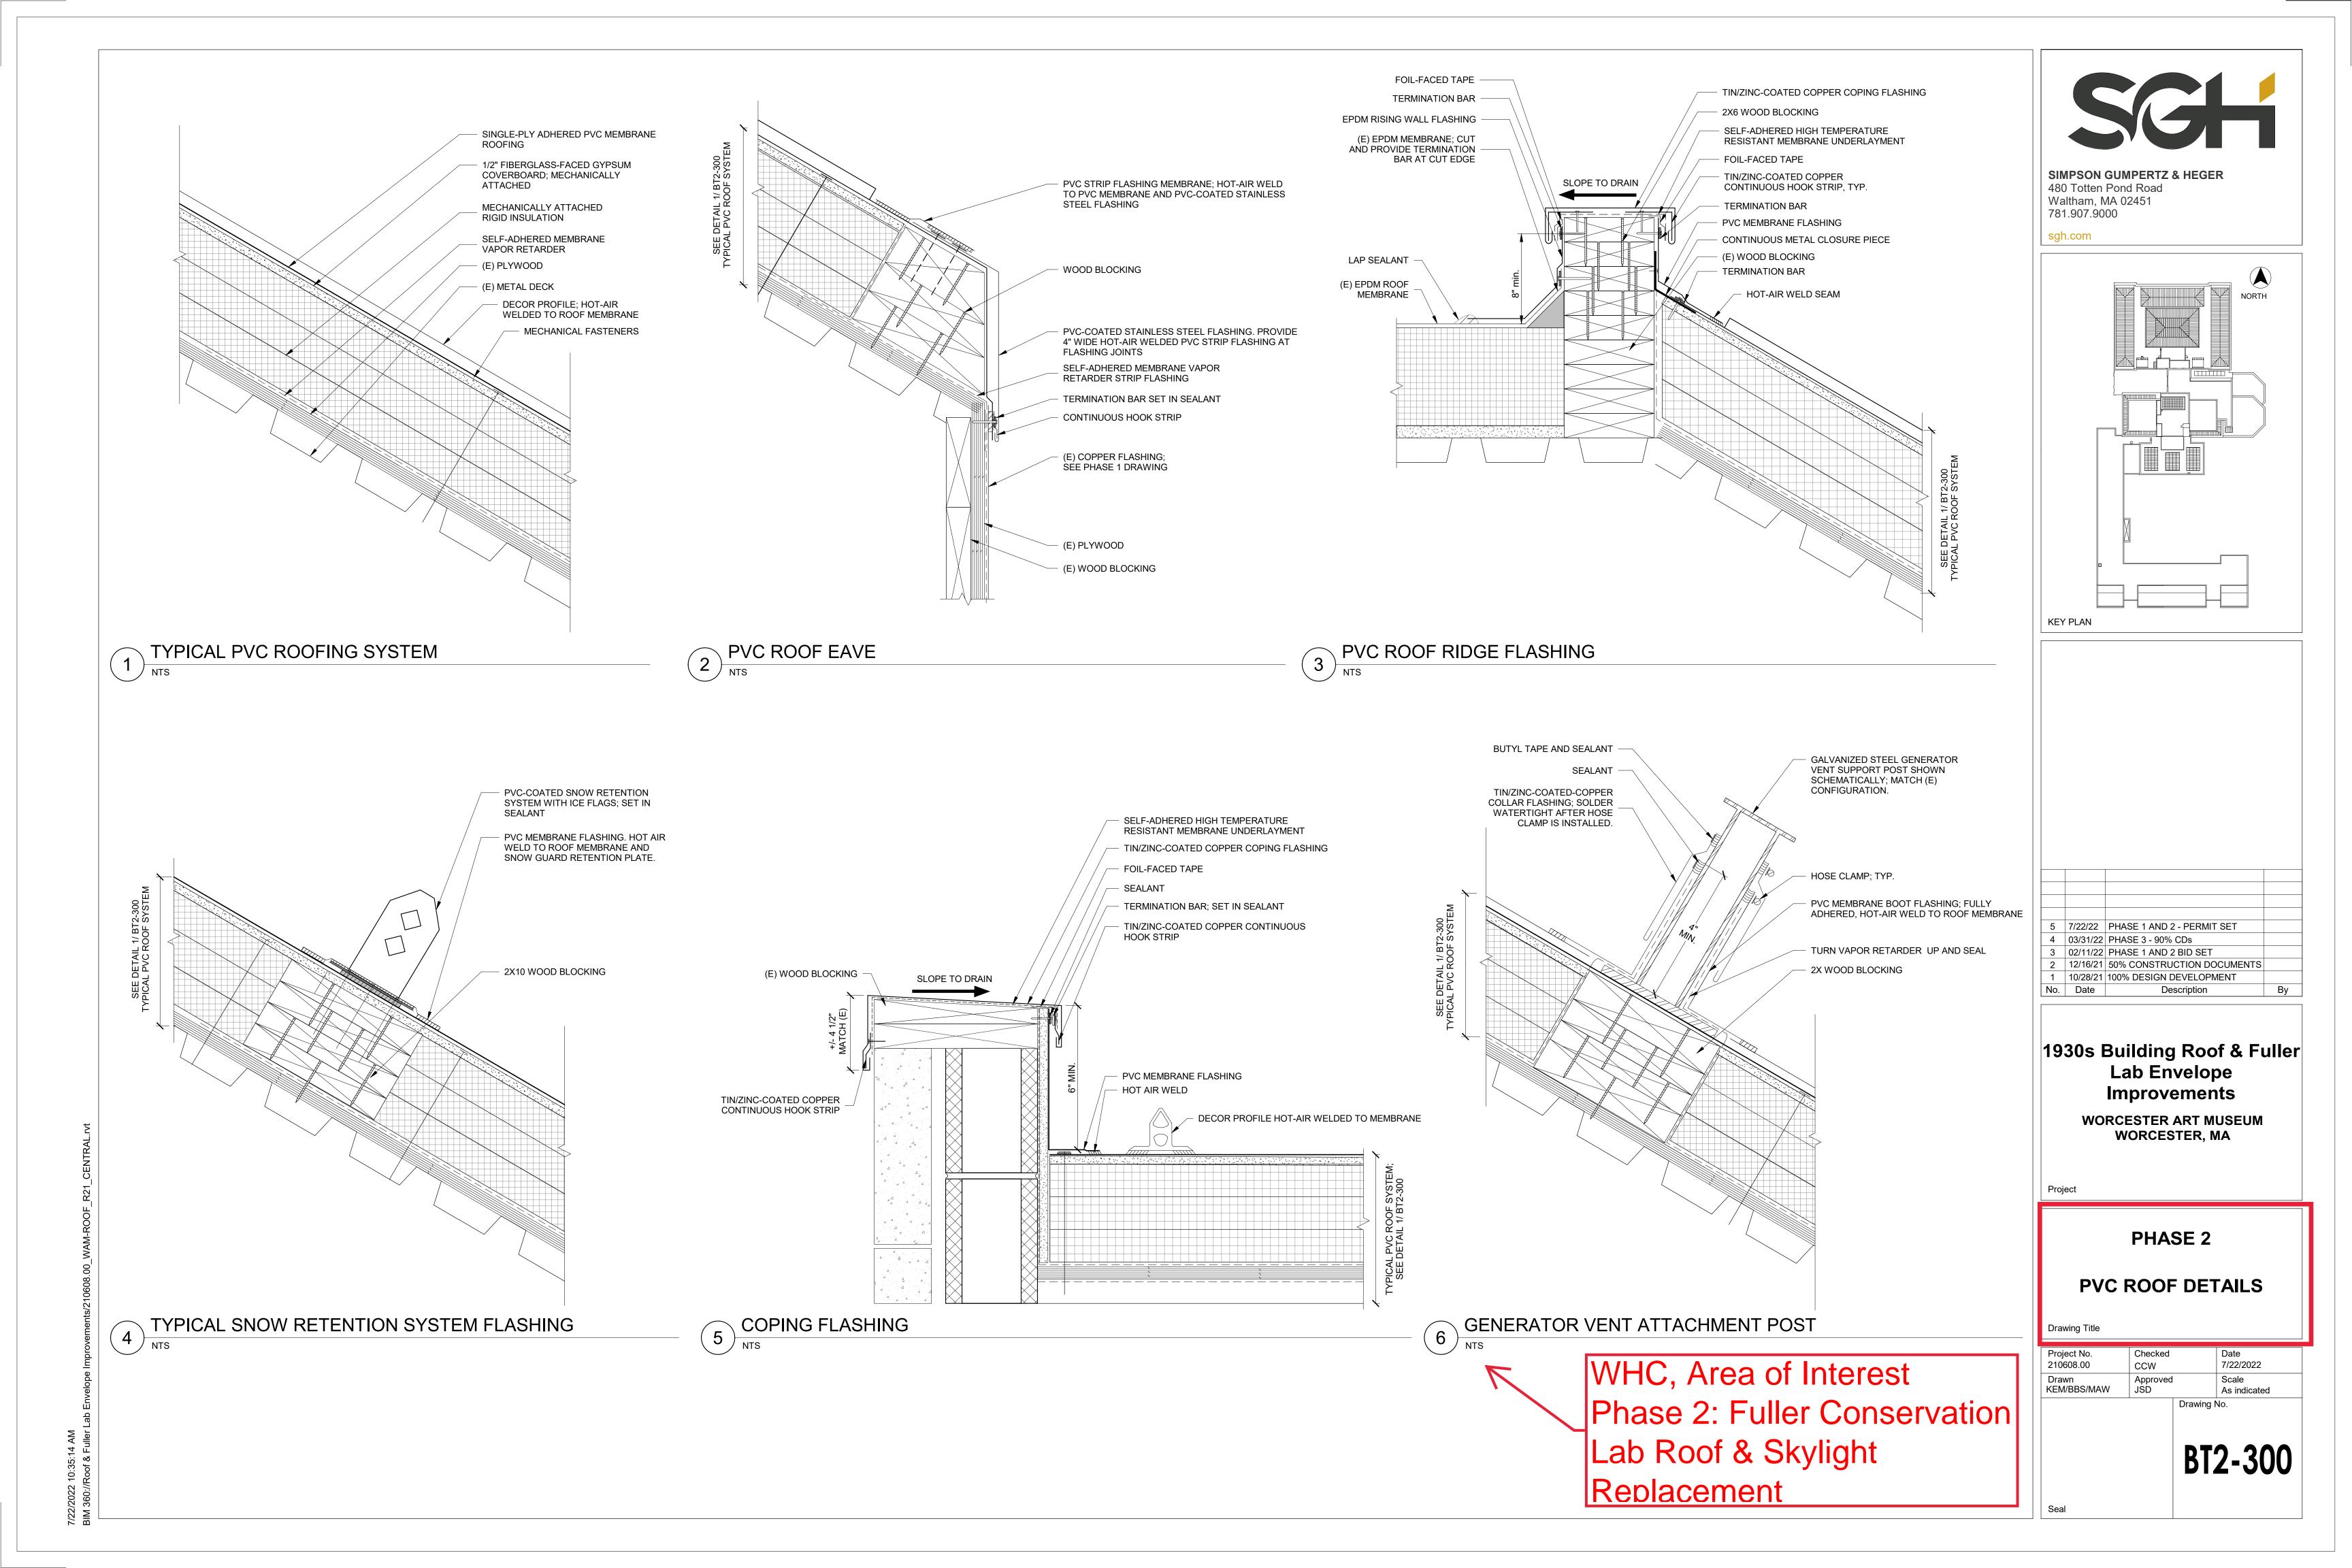
PHASE 2 **FULLER LAB WALL PART** PLAN AND INTERIOR **ELEVATION**


Project No.	Checked		Date
210608.00	CCW		7/22/2022
Drawn	Approved		Scale
KEM/BBS/MAW	JSD		As indicated
		Drawing N	No.

SEAL INTERIOR AVB MEMBRANE AIRTIGHT TO UNDERSIDE OF (E) SLAB AND (E) PARTITION WALLS (NOT SHOWN); TYP. WRAP AND SEAL AROUND

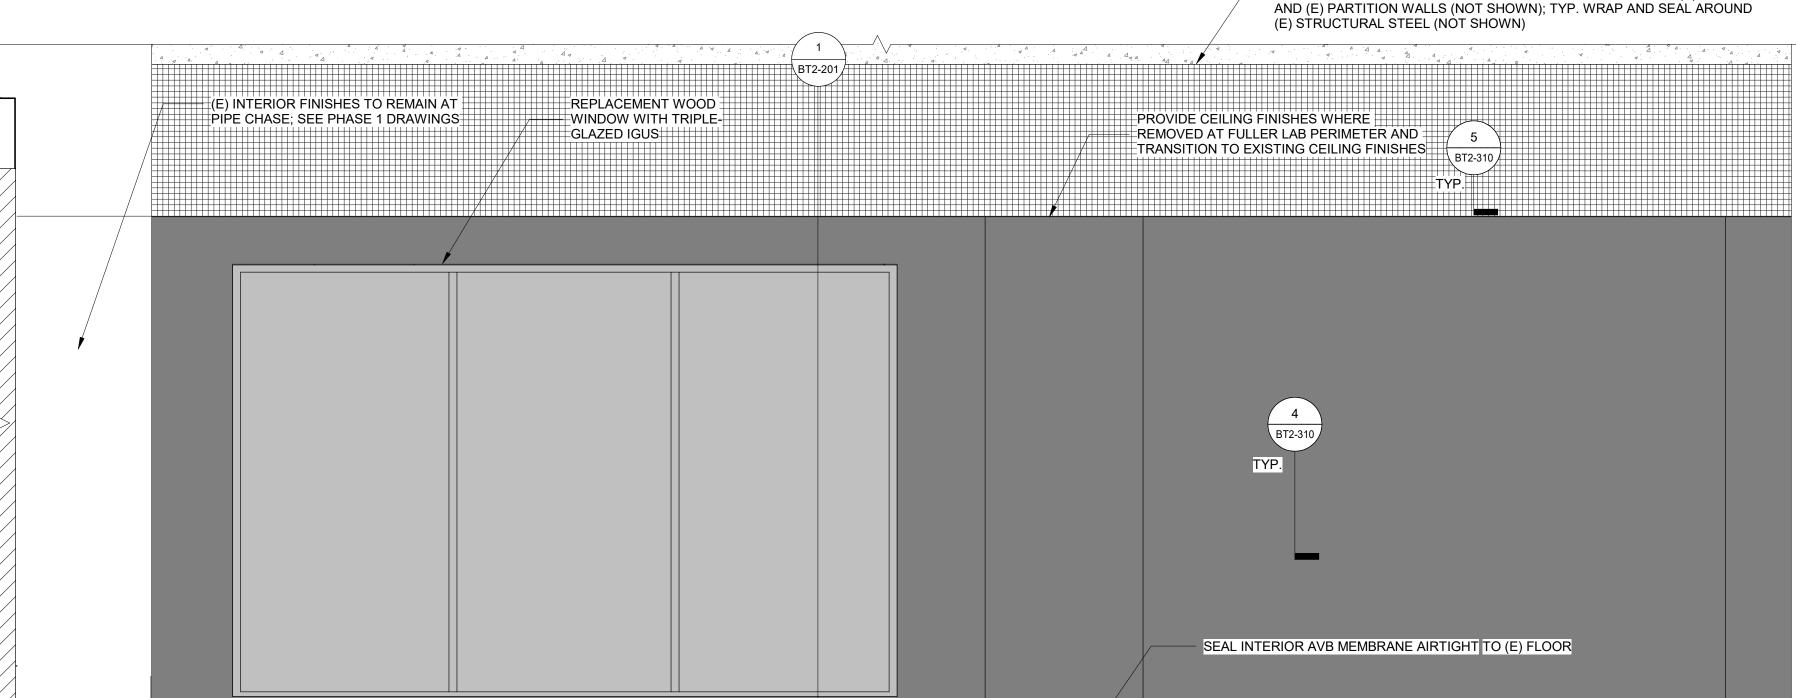

FULLER LAB PARTIAL INTERIOR ELEVATION




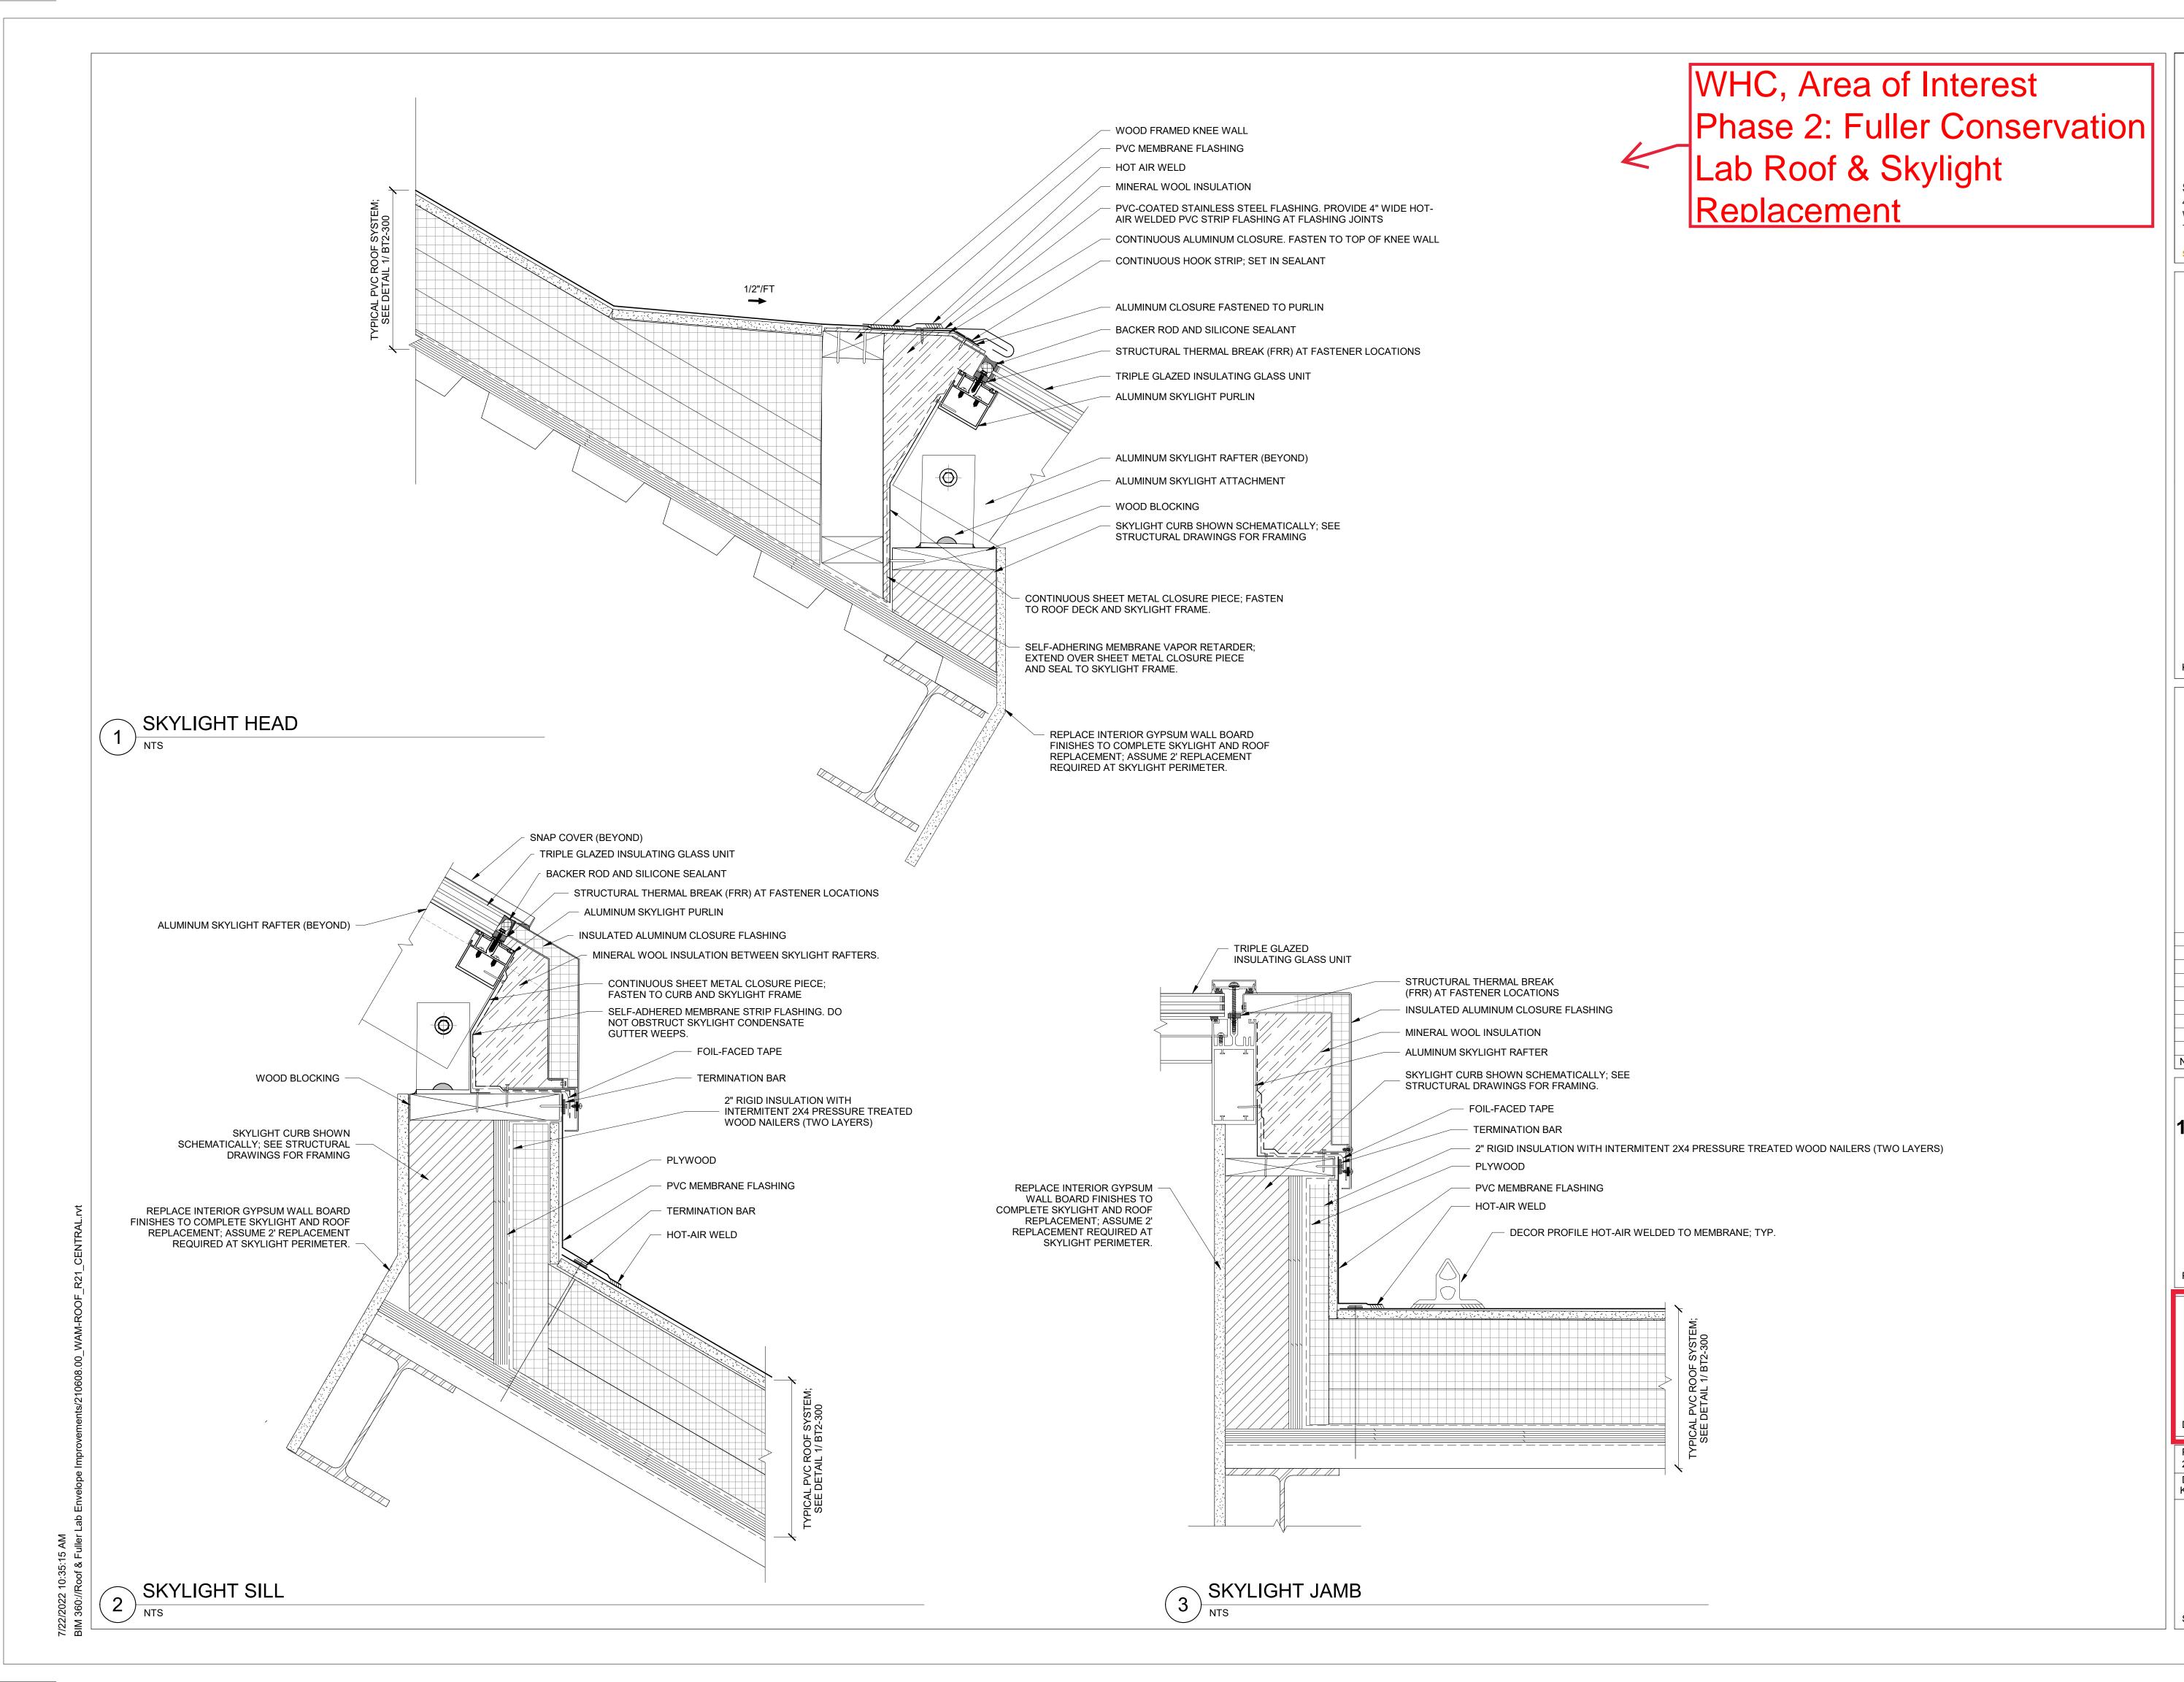



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1	10/28/21	100% DESIGN DEVELOPMENT	
Vo.	Date	Description	Ву

1930s Building Roof & Fuller Lab Envelope **Improvements**
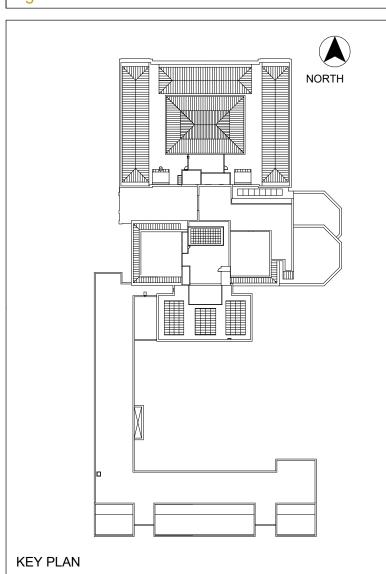
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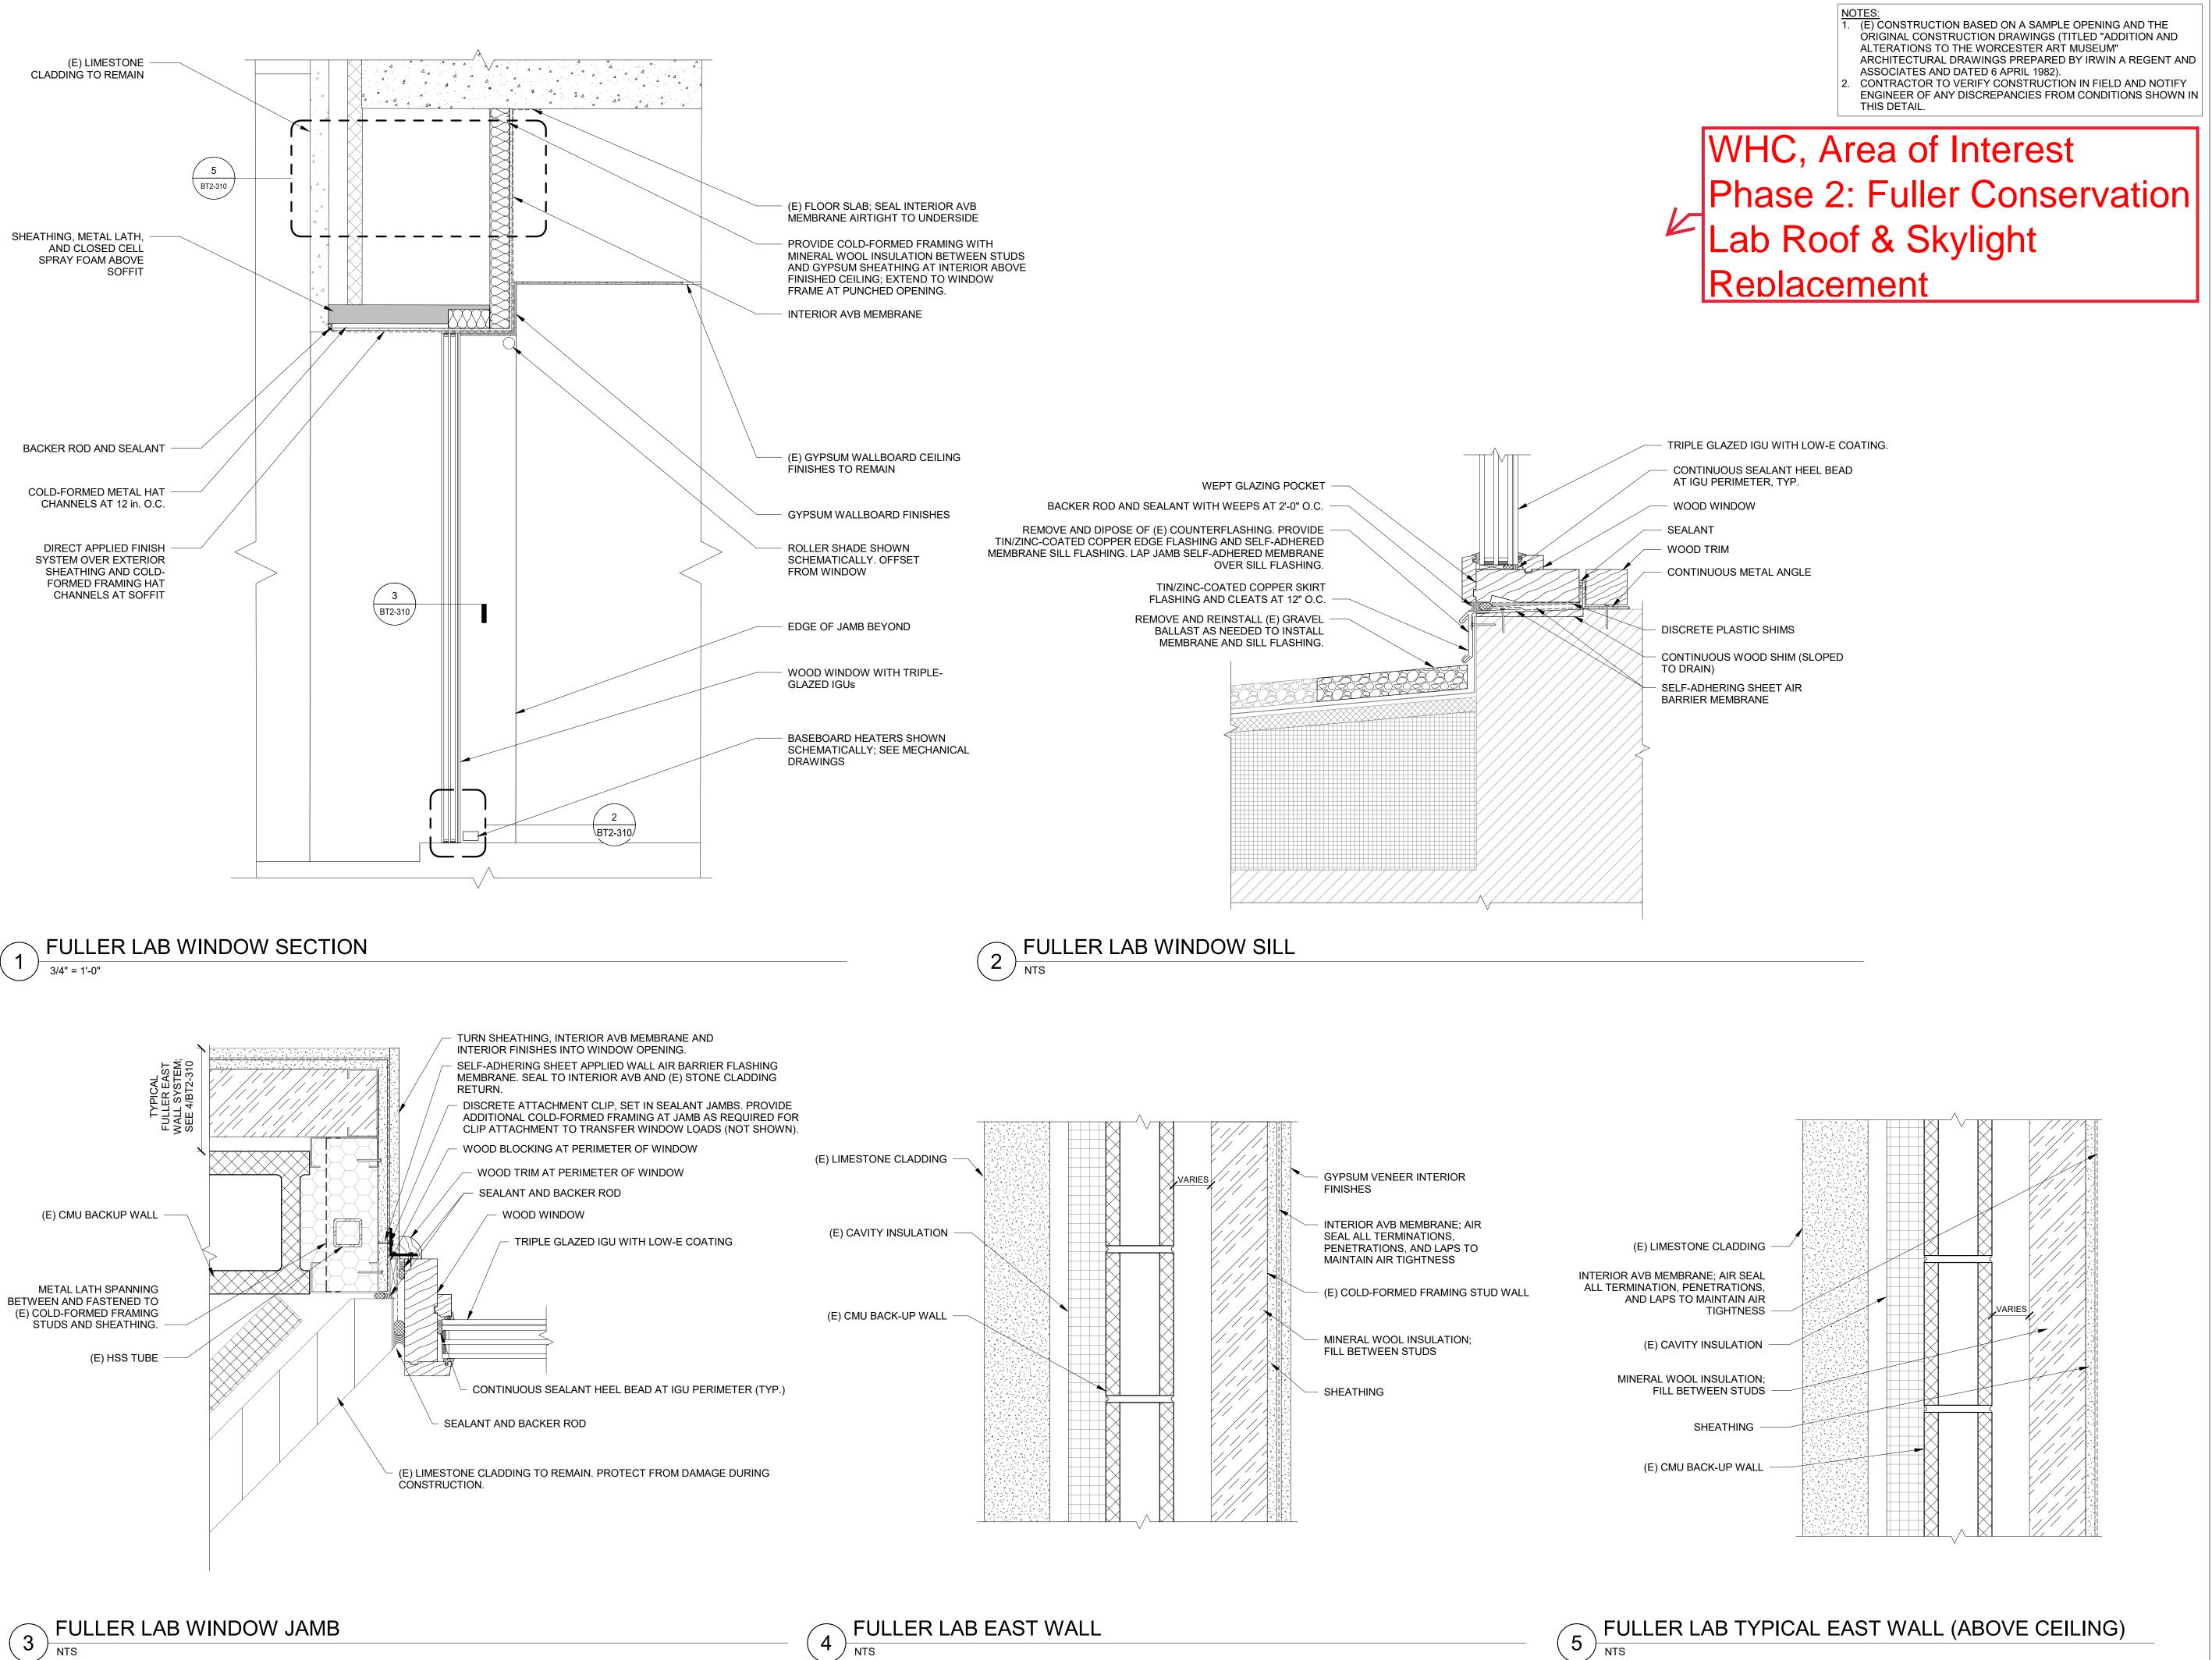
PHASE 2

PVC ROOF DETAILS

Project No.

210608.00	CCW		7/22/2022
Drawn KEM/BBS/MAW	Approved JSD		Scale /As indicated
		Drawing I	No.


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5	7/22/22	PHASE 1 AND 2 - PERMIT SET	
4	03/31/22	PHASE 3 - 90% CDs	
3	02/11/22	PHASE 1 AND 2 BID SET	
2	12/16/21	50% CONSTRUCTION DOCUMENTS	
1	10/28/21	100% DESIGN DEVELOPMENT	1
No.	Date	Description	Ву
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1930s Building Roof & Fuller Lab Envelope Improvements

WORCESTER ART MUSEUM WORCESTER, MA

Project

PHASE 2

WINDOW DETAILS

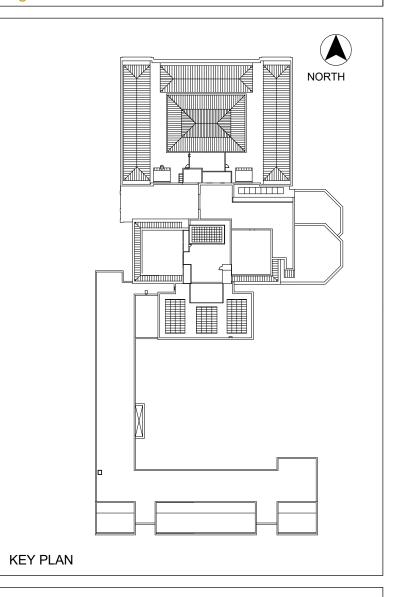Drawing Title


Project No.

Seal

210608.00	CCW		7/22/2022
Drawn KEM/BBS/MAW	Approved JSD		Scale As indicated
		Drawing N	No.

Checked

BT2-310

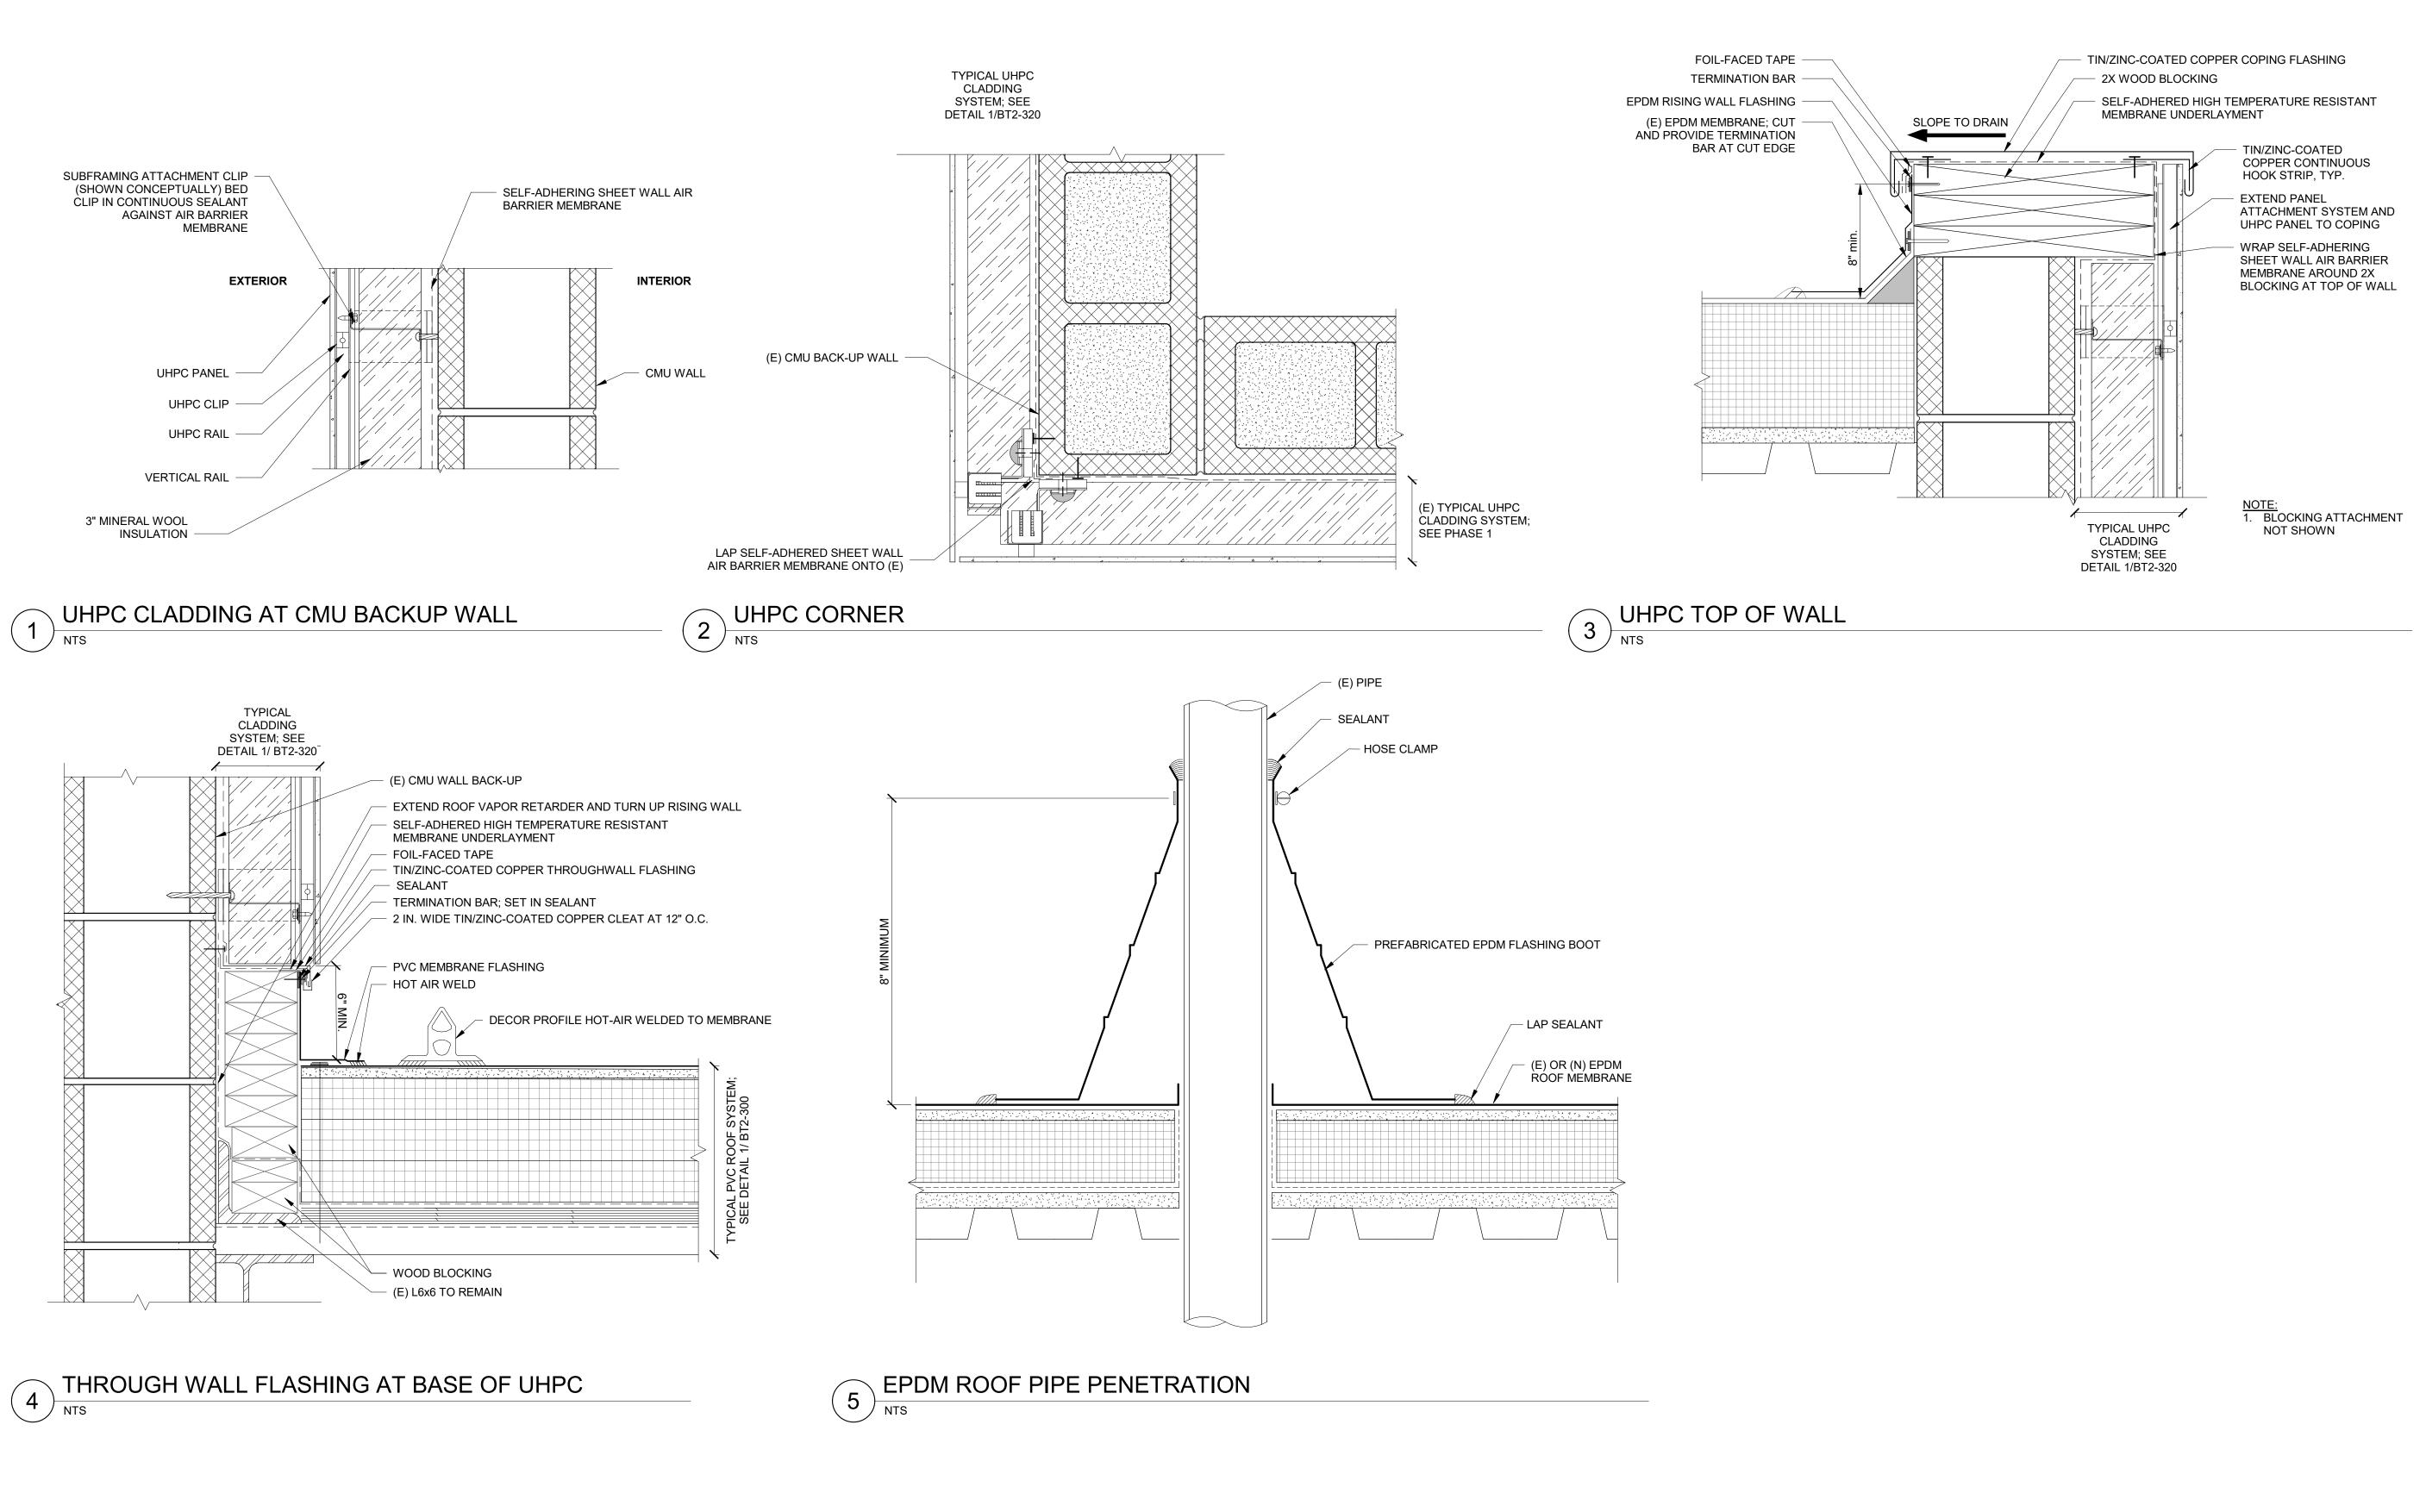

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NORTH NORTH

5 7/22/22 PHASE 1 AND 2 - PERMIT SET
4 03/31/22 PHASE 3 - 90% CDs
3 02/11/22 PHASE 1 AND 2 BID SET
2 12/16/21 50% CONSTRUCTION DOCUMENTS
1 10/28/21 100% DESIGN DEVELOPMENT
No. Date Description By

1930s Building Roof & Fuller Lab Envelope Improvements

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PHASE 2


UHPC CLADDING DETAILS

Drawing T


Project No.	Checked		Date
210608.00	CCW		7/22/2022
Drawn	Approved		Scale
KEM/BBS/MAW	JSD		As indicated
	Drawing N		No.

BT2-320

WHC, Area of Interest
Phase 2: Fuller Conservation
Lab Roof & Skylight
Replacement

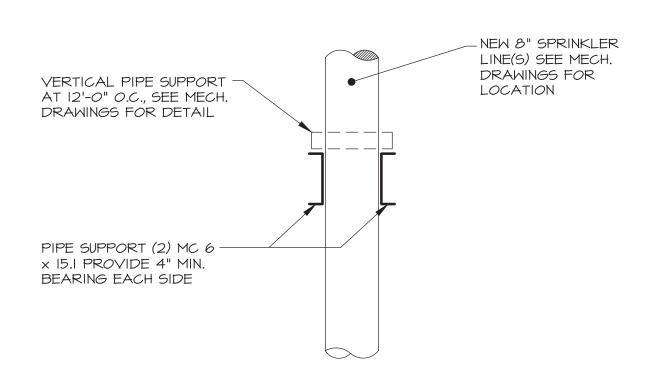



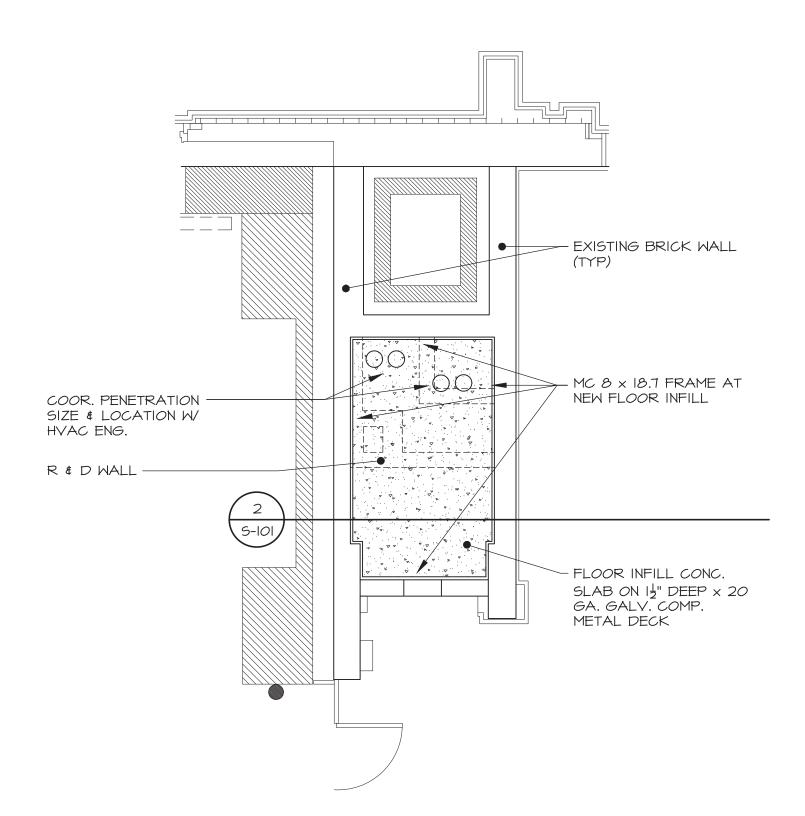



AND CONDITION.

ANCHOR (1500#)

NOTES:

<u>GENERAL</u>

- I. ALL WORK SHALL CONFORM TO THE MASSACHUSETTS STATE BUILDING CODE, ITS APPLICABLE REFERENCED STANDARDS, AND LOCAL CODES.
- 2. IT IS THE RESPONSIBILITY OF THE GENERAL CONTRACTOR TO VERIFY ALL EXISTING CONDITIONS AND DIMENSIONS AS THEY RELATE TO NEW CONSTRUCTION. REPORT TO THE ARCHITECT/ENGINEER ALL OBSERVA-TIONS AND ANY DISCREPANCIES BEFORE PROCEEDING WITH ANY WORK.
- 3. IT IS THE RESPONSIBILITY OF THE GENERAL CONTRACTOR TO PROVIDE FOR A SAFE AND EFFICIENT METHOD OF SHORING AND/OR BRACING THE EXISTING STRUCTURE DURING BOTH DEMOLITION AND NEW CONSTRUCTION PHASES. SUBMIT AN OUTLINE OF PROPOSED PROCEDURE TO THE ARCHITECT/ENGINEER BEFORE DEMOLITION OPERATIONS BEGIN.
- 4. SUBMIT COMPLETE SHOP DRAWINGS AND SCHEDULES OF ALL STRUCTURAL ELEMENTS TO THE ENGINEER FOR APPROVAL PRIOR TO FABRICATION.

<u>CONCRETE</u>

- ALL CONCRETE WORK SHALL CONFORM TO ACI 318 \$ 301 REQUIREMENTS THIS SHALL INCLUDE PROPORTIONING OF CONCRETE MIX, CONCRETE TESTING, PLACEMENT OF CONCRETE, AND CURING PROCEDURES.
- 2. CONCRETE SHALL HAVE THE FOLLOWING 28-DAY COMPRESSIVE STRENGTH: a. ALL OTHER CONCRETE - 4,000 PSI
- 3. CONCRETE REINFORCING SHALL BE IN ACCORDANCE WITH ASTM A615, GRADE 60. INSTALLATION SHALL BE IN ACCORDANCE WITH ACI 315 AND
- 4. WELDED WIRE FABRIC SHALL BE IN ACCORDANCE WITH ASTM A185.

STRUCTURAL STEEL


- ALL WORK SHALL CONFORM TO THE AMERICAN INSTITUTE OF STEEL CONSTRUCTION SPECIFICATIONS AND ITS CODE OF STANDARD PRACTICE.
- 2. ALL WELDING OPERATIONS SHALL BE PERFORMED BY AWS CERTIFIED WELDERS IN CONFORMANCE WITH ALL APPLICABLE REQUIREMENTS.
- 3. ALL NEW STRUCTURAL STEEL SHALL BE GIVEN ONE COAT OF AN APPROVED SHOP PAINT, APPLIED IN ACCORDANCE WITH MANUFACTURER'S RECOMMENDATIONS, UNLESS NOTED OTHERWISE. SHOP PAINTING OF
- 4. AFTER ERECTION IS COMPLETE, TOUCHUP ALL SHOP PRIMED COATS DAMAGED DURING TRANSPORTATION AND ERECTION, AND PRIME ALL FIELD WELDS USING THE SAME PAINT USED FOR SHOP PRIMING.

STRUCTURAL STEEL SHALL CONFORM TO SSPC-PS TOI.


5. UNLESS NOTED OTHERWISE, PROVIDE A 1/2"X8"X8" BASE PLATE W/2-3/4"DIA. BOLTS (TYPICAL) UNDER ALL STEEL BEAMS

STEEL DECKS

- ALL STEEL DECKING SHALL CONFORM TO THE STEEL DECK INSTITUTE (SDI) APPLICABLE REQUIREMENTS. INSTALLATION SHALL BE PER THE MANUFACTURER'S RECOMMENDATIONS IN ACCORDANCE WITH SDI SPECIFICATIONS.
- 2. DECK SHEETS SHALL BE PLACED IN ACCORDANCE WITH APPROVED ERECTION LAYOUT DRAWINGS (INCLUDING FASTENING SCHEDULE) SUPPLIED BY THE DECK MANUFACTURER AND IN CONFORMANCE WITH THE MANUFACTURER'S STANDARDS. UNLESS NOTED OTHERWISE, END LAPS SHALL OCCUR OVER SUPPORTS AND SHALL NOT BE LESS THAN 2 INCHES.
- 3. FLOOR DECK TO BE I I/2" LOK. FLOOR COMPOSITE FLOOR DECK, 20 GAGE GALV. METAL DECK BY U.S.D. OR EQUAL

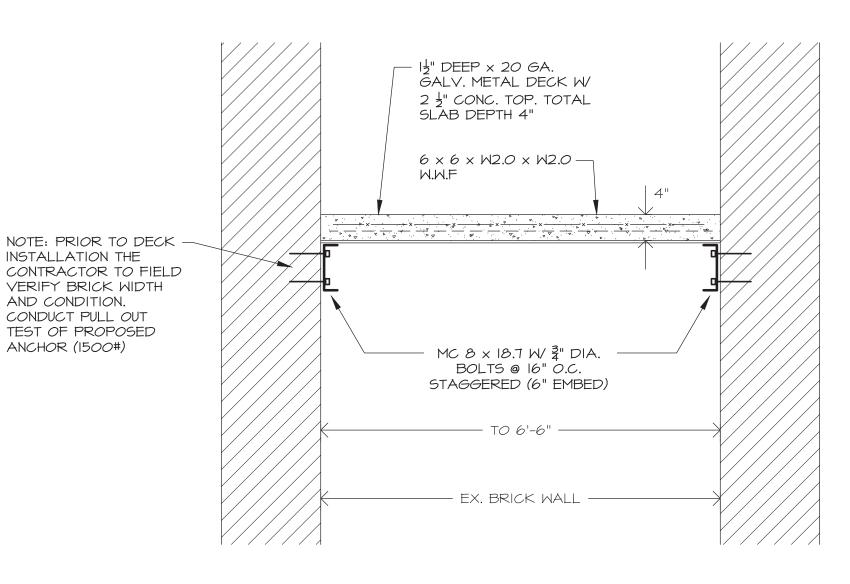




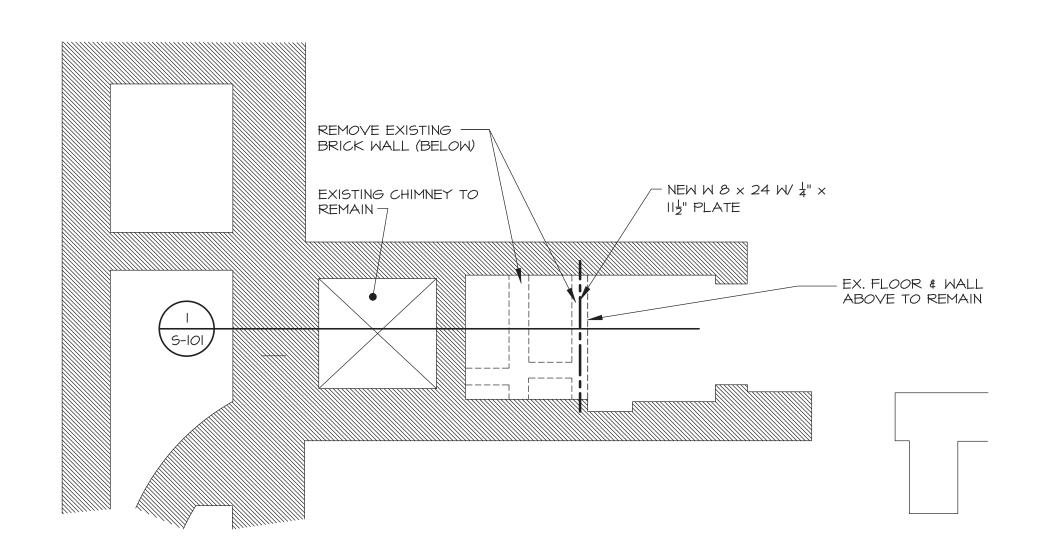

PARTIAL PLAN @ ROOF



- ALL WORK SHALL BE IN CONFORMANCE WITH THE AMERICAN FOREST & PAPER ASSOC. STANDARDS AND SPECIFICATIONS, LATEST ADDITION.
- 2. ALL LUMBER USED IN A STRUCTURAL CAPACITY SHALL BE 19% KILN DRIED HEM-FIR NO. I OR EQUAL, FB. 1200 PSI.
- 3. ANY WOOD IN DIRECT CONTACT WITH CONCRETE OF MASONRY, EXPOSED TO UNHEATED BASEMENT AND CRAWL SPACES, OR EXPOSED TO THE EXTERIOR SHALL BE PRESSURE TREATED.
- 4. ALL FASTENERS SHALL BE IN CONFORMANCE WITH THE FASTENING SCHEDULE IN THE RHODE ISLAND STATE BUILDING CODE. FASTENERS EXPOSED TO THE WEATHER SHALL BE GALVANIZED OR STAINLESS STEEL.

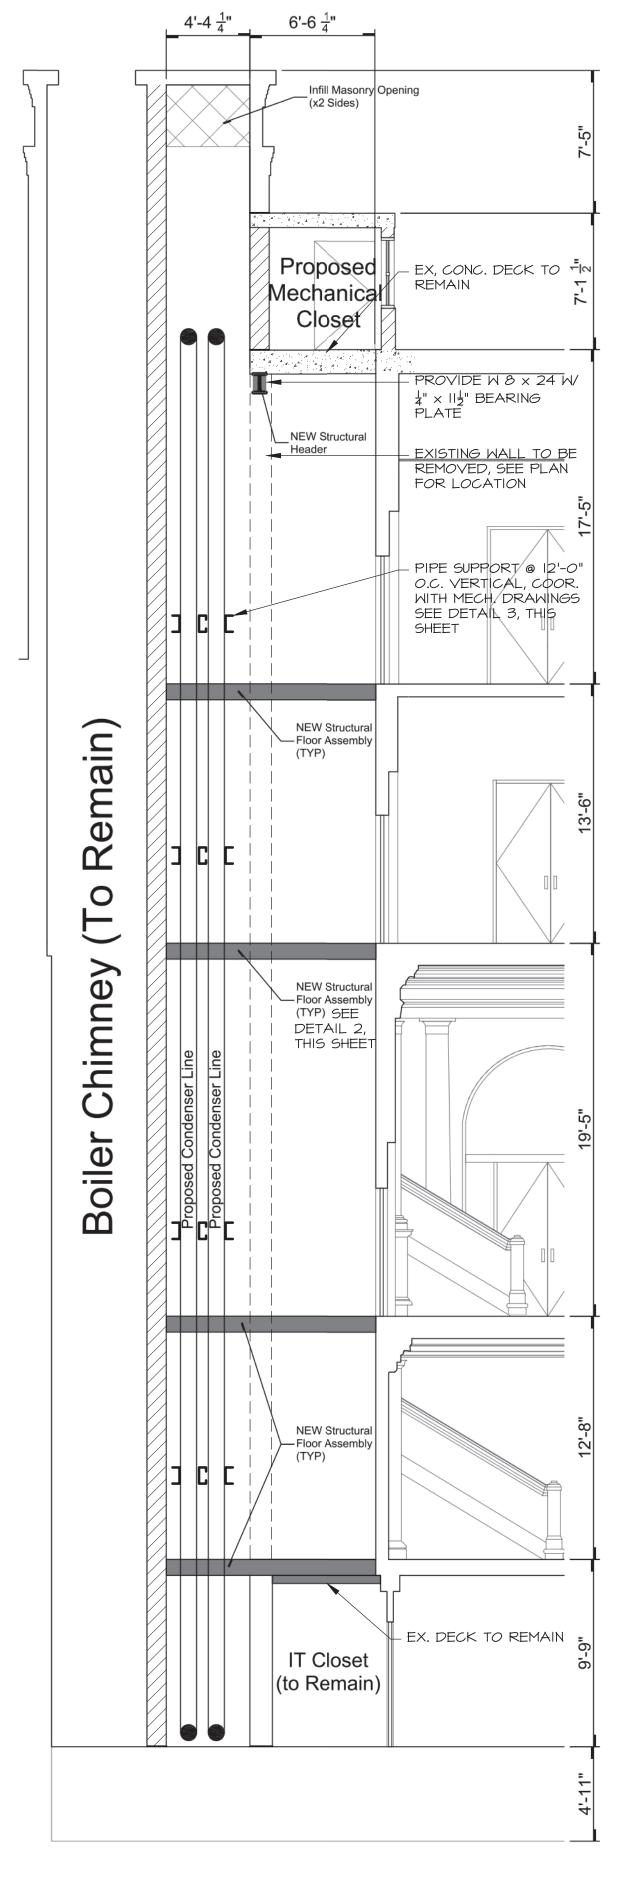



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General Notes:

1) The architectural drawings express the intent of that of owner's consultants, for utility services, civil, structural, mechanical, electrical, plumbing, fire protection, fire alarm, landscape, furnishings, etc. drawing set, including all architectural sheets, and achieve the design intent and comply with all regulate equirements of the authorities having jurisdiction (AHJ).

2) Should drawings, schedules, specifications or notes

disagree in themselves or with each other, the contractor

shall notify the architect for clarification before proceeding with work. 3) These drawings are strictly graphic representation and are not to be scaled; in every case the written notes and dimensions shall be followed. All existing conditions and/or dimensions affected by work in place shall be

verified in the field and the architect notified of any discrepancies prior to proceeding with related work. 4) All dimensions taken from finished face of walls unless

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Plans, Sections & Notes